

FRISCO BAY MARINA SITE AND LANDSCAPE IMPROVEMENTS

277 MARINA ROAD FRISCO . COLORADO

BID DOCUMENTS 19 SEPTEMBER 2022

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PROJECT MANUAL

PROJECT TEAM

OWNER:

TOWN OF FRISCO 1 EAST MAIN ST P.O. BOX 4100 FRISCO . CO . 80443 970.668.2559

CIVIL ENGINEER:

MURRAYSMITH

850 W SOUTH BOULDER ROAD, SUITE 200 LOUISVILLE . CO . 80027 303.402.6984



409 east main street p o box 4175 frisco . colorado 80443 970 453 0444



frisco bay marina site and landscape improvements

> 277 marina road frisco . colorado

PROJECT # 2161

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ISSUE:

review	5 may 2022
bid set	24 may 2022
bid documents	19 sept 2022

COVER SHEET	
CS	

SURVEYOR:

SCHMIDT LAND SURVEYING, INC. P.O BOX 5761 FRISCO . CO . 80443 970-409-9963

LANDSCAPE ARCHITECT:

NORRIS DESIGN 409 E MAIN ST. SUITE 207 P.O. BOX 2320 FRISCO . CO . 80443 970.368.7068

GENERAL NOTES

1. ALL MATERIALS AND CONSTRUCTION SHALL BE IN ACCORDANCE WITH THE CDOT STANDARD SPECIFICATIONS FOR ROAD AND BRIDGE CONSTRUCTION, LATEST EDITION, AND THE TOWN OF FRISCO ENGINEERING STANDARDS, MATERIAL SPECIFICATIONS AND DRAWINGS.

2. THE CONTRACTOR SHALL POTHOLE AND VERIFY LOCATIONS, ELEVATIONS, TYPES AND SIZES OF ALL EXISTING UTILITIES PRIOR TO CONSTRUCTING NEW PIPING FAR ENOUGH IN ADVANCE TO ALLOW NECESSARY ADJUSTMENTS IN GRADE AND SHALL NOTIFY ENGINEER OF NEED TO ADJUST PIPING INSTALLATION ACCORDINGLY. POTHOLING SHALL SUFFICIENTLY PRECEDE LAYING OF PIPE TO ALLOW REQUIRED ELEVATION ADJUSTMENTS TO BE ACCOMPLISHED WITHOUT REWORK. ELEVATION ADJUSTMENTS SHALL BE EXPECTED AND ARE INCIDENTAL TO THE WORK. DEFLECT PIPE AS REQUIRED AND WITHIN SPECIFIED TOLERANCES TO AVOID EXISTING UTILITIES AND COMPLETE TIE-INS.

3. LOCATIONS OF EXISTING UTILITIES ARE BASED ON INFORMATION SUPPLIED BY THE UTILITIES AND CONSIDERED APPROXIMATE ONLY. AS REQUIRED BY STATE LAW, THE CONTRACTOR SHALL OBTAIN UTILITY LOCATES PRIOR TO COMMENCING CONSTRUCTION.

4. CONTRACTOR SHALL PROVIDE ENGINEER WITH MINIMUM 24 HOURS NOTICE WHEN POTHOLING WILL BE COMPLETE. COORDINATE WITH ENGINEER TO REVIEW UTILITY INVESTIGATIONS AND TO MAKE APPROPRIATE ADJUSTMENTS FOR ANY ALIGNMENT CONFLICTS WHERE CONNECTING TO EXISTING UTILITIES.

5. COLORADO LAW REQUIRES THE CONTRACTOR TO FOLLOW THE RULES ADOPTED BY THE COLORADO UTILITY NOTIFICATION CENTER. THOSE RULES ARE SET FORTH IN THE 2017 PROCEDURES GUIDE, EXCAVATION HANDBOOK & TITLE 9 SAFETY- INDUSTRIAL AND COMMERCIAL ARTICLE 1.5 EXCAVATION REQUIREMENTS 9-1.5-101 THROUGH 9-1.5-107. THE CONTRACTOR MAY OBTAIN COPIES OF THE RULES BY DOWNLOADING FROM THE WEBSITE HTTP://COLORADO811.ORG/EDUCATION CONSOLIDATED/ OR CALLING UTILITY NOTIFICATION CENTER.

6. PROVIDE "AS CONSTRUCTED" DRAWINGS INDICATING ALL CHANGES IN GRADE, ALIGNMENT, FITTINGS AND MATERIALS INSTALLED AND ANY OTHER UTILITIES OR OBSTACLES NOT SO INDICATED ON THESE PLANS.

7. AT THE END OF EACH WORK DAY ALL OPEN TRENCHES SHALL BE BACKFILLED AND ALL TRENCHES SHALL EITHER BE TEMPORARILY PAVED OR FILLED TO THE SATISFACTION OF THE PROJECT ENGINEER OR TOWN REPRESENTATIVE.

8. CONTRACTOR SHALL PROTECT ALL PROPERTY CORNERS, SURVEY MONUMENTS AND CONTROL SURVEY MONUMENTS DISTURBED DURING CONSTRUCTION SHALL BE REPLACED AT CONTRACTOR'S EXPENSE, WITH APPROPRIATE SURVEY FILED WITH COUNTY SURVEYOR.

9. CONTRACTOR SHALL SUPPORT AND PROTECT AS NECESSARY ANY PIPE OR CONDUIT EXPOSED AS PART OF NEW PIPE TRENCH EXCAVATION. CONTRACTOR SHALL MAINTAIN ALL EXISTING UTILITIES IN SERVICE AT ALL TIMES AND SHALL COORDINATE WITH RESPECTIVE UTILITY COMPANIES TO MAINTAIN AND PROTECT SERVICES.

10. THE CONTRACTOR SHALL DISPOSE OF ALL REMOVED OR REPLACED MATERIAL AND EQUIPMENT IN ACCORDANCE WITH ALL APPLICABLE REGULATIONS.

11. CONTRACTOR TO LEAVE ALL AREAS OF PROJECT FREE OF DEBRIS AND UNUSED CONSTRUCTION MATERIAL

12. ALL EXISTING FEATURES INCLUDING, BUT NOT LIMITED TO, ROADWAYS, STRUCTURES, LOTS, CURBS, SIDEWALKS, FENCES, WALLS, TREES AND PLANTINGS, DITCHES, MAILBOXES, SIGNS, PIPING AND UTILITIES DISTURBED DURING CONSTRUCTION SHALL BE RESTORED TO AS GOOD OR BETTER THAN EXISTING CONDITION UNLESS OTHERWISE SPECIFIED. IF A UTILITY IS DAMAGED DURING CONSTRUCTION, THE CONTRACTOR SHALL CONTACT OWNER OF UTILITY FOR INSPECTION OF DAMAGE PRIOR TO REPAIRS. CONTRACTOR SHALL REPAIR ALL UTILITY SERVICES DAMAGED DURING CONSTRUCTION AND SUCH REPAIR SHALL BE CONSIDERED INCIDENTAL.

13. PRIOR TO BACKFILLING ANY UTILITY CONTRACTOR SHALL NOTIFY TOWN STAFF TO OBTAIN GEOGRAPHIC INFORMATION SYSTEM (GIS) INFORMATION ON ALL FITTINGS, CAPS, VALVES, METERS, AND CHANGES OF DIRECTION.

14. THE CONTRACTOR SHALL LIMIT ALL WORK, STAGING AND STORAGE AREAS TO THE PROJECT SITE WITHIN THE LIMITS OF DISTURBANCE AS SHOWN ON THE PLANS.

15. PROVIDE THRUST BLOCKS AT ALL BENDS, VALVES, TEES, AND WYES.

TOPOGRAPHIC SURVEY NOTES:

SURVEY WAS COMPLETED BY SCHMIDT LAND SURVEYING, INC.

2. DATE OF SURVEY: EAST PORTION PARKING APRIL 16, 2018. UPDATED SEPTEMBER 2019 AFTER INITIAL BIG DIG CONSTRUCTION. UPDATE AREA MARCH AND APRIL 2022.

3. PROJECT BENCHMARK: ELEVATIONS ARE BASED ON DENVER WATER DEPARTMENT DATUM WHICH IS HIGHER BY 1.85' THAN U.S.G.S. SEA LEVEL DATUM (1929). CONTROL ELEVATIONS WERE HELD FROM RANGE WEST SURVEYOR'S ORIGINAL TOPOGRAPHY DONE OCTOBER 2012. HORIZONTAL COORDINATES ARE NAD 1983 DATUM.

4. SCHMIDT LAND SURVEYING, INC. DID NOT PERFORM A TITLE SEARCH OF THE SUBJECT PROPERTY TO ESTABLISH OWNERSHIP, EASEMENTS OR RIGHT-OF-WAY OF RECORD.

PROJECT CONTACTS

OWNER

TOWN OF FRISCO, DEPT OF PUBLIC WORKS P.O. BOX 4100 P.P. FRISCO, CO 80443 CONTACT: ADDISON CANINO

E: ADDISONC@TOWNOFFRISCO.COM P: 970-331-6632

ELECTRIC UTILITY: XCEL ENERGY P.O. BOX 1819 SILVERTHORNE, CO 80498 CONTACT: AMY LAGACE E: AMY.LAGACE@XCELENERGY.COM

P: 970-262-4033

WATER UTILITY: FRISCO WATER DEPARTMENT 0102 SCHOOL RD FRISCO, COLORADO 80443 CONTACT: RYAN THOMPSON E: RYANT@TOWNOFFRISCO.COM P: 970-668-9156

SEWER UTILITY: FRISCO SANITATION DISTRICT P: 970-668-3723

EROSION CONTROL NOTES:

1. CONTRACTOR SHALL PREPARE, SUBMIT, AND ACQUIRE A COLORADO DEPARTMENT OF PUBLIC HEALTH AND THE ENVIRONMENT (CPDHE) CONSTRUCTION STORMWATER DISCHARGE PERMIT PRIOR TO BEGINNING ANY SITE DISTURBING ACTIVITY IF DISTURBING GREATER THAN ONE ACRE OF LAND AS PART OF THIS PROJECT. CONTRACTOR SHALL PROVIDE PAYMENT FOR ALL REQUIRED PERMIT FEES.

2. CONTRACTOR SHALL INSTALL AND MAINTAIN EROSION/SEDIMENTATION CONTROL DURING CONSTRUCTION (ANY TIME OF YEAR) IN ACCORDANCE WITH THE CDPHE EROSION PREVENTION AND SEDIMENT CONTROL REQUIREMENTS, THE STANDARD CONSTRUCTION SPECIFICATIONS FOR THIS PROJECT AND THE EROSION CONTROL NOTES INCLUDED BELOW AND WITHIN THESE PLANS. IF DISCREPANCIES BETWEEN STANDARDS OCCUR, THE MORE STRINGENT REGULATION SHALL APPLY.

3. APPROVAL OF THIS EROSION SEDIMENTATION CONTROL (ESC) PLAN DOES NOT CONSTITUTE AN APPROVAL OF PERMANENT ROAD OR DRAINAGE DESIGN (E.G.: SIZE AND LOCATION OF ROADS, PIPES, RESTRICTIONS, CHANNELS, RETENTION FACILITIES, UTILITIES, ETC.)

4. THE IMPLEMENTATION OF EROSION/SEDIMENTATION CONTROL (ESC) PLANS AND THE CONSTRUCTION, MAINTENANCE, REPLACEMENT, AND UPGRADING OF THESE ESC FACILITIES IS THE RESPONSIBILITY OF THE CONTRACTOR UNTIL ALL CONSTRUCTION IS COMPLETED AND APPROVED AND VEGETATION/LANDSCAPING IS ESTABLISHED.

5. THE BOUNDARIES OF THE LIMITS OF WORK SHALL BE CLEARLY FLAGGED IN THE FIELD PRIOR TO CONSTRUCTION. DURING THE CONSTRUCTION PERIOD, NO DISTURBANCE BEYOND THE FLAGGED LIMITS OF WORK SHALL BE PERMITTED. THE FLAGGING SHALL BE MAINTAINED BY THE CONTRACTOR FOR THE DURATION OF CONSTRUCTION.

6. ESC FACILITIES MUST BE CONSTRUCTED IN CONJUNCTION WITH ALL CLEARING AND GRADING ACTIVITIES, AND IN SUCH A MANNER AS TO ENSURE THAT SEDIMENT AND SEDIMENT LADEN WATER DO NOT ENTER THE DRAINAGE SYSTEM, ROADWAYS, OR VIOLATE APPLICABLE WATER STANDARDS.

7. THE ESC FACILITIES SHALL BE INSPECTED DAILY BY THE CONTRACTOR AND MAINTAINED AS NECESSARY TO ENSURE THEIR CONTINUED FUNCTIONALITY.

8. THE ESC FACILITIES ON INACTIVE SITES SHALL BE INSPECTED AND MAINTAINED A MINIMUM OF ONCE A MONTH OR WITHIN 24 HOURS FOLLOWING A STORM EVENT.

9. STABILIZED CONSTRUCTION ENTRANCES SHALL BE INSTALLED AT THE BEGINNING OF CONSTRUCTION AND MAINTAINED FOR THE DURATION OF THE PROJECT. ADDITIONAL MEASURES MAY BE REQUIRED TO ENSURE THAT ALL PAVED AREAS ARE KEPT CLEAN FOR THE DURATION OF THE PROJECT.

10. CONTRACTOR SHALL PROVIDE DUST CONTROL AS REQUIRED.

11. SEEDING SHALL BE PERFORMED NO LATER THAN SEPTEMBER 1 FOR EACH PHASE OF CONSTRUCTION ROUGHEN AND SEED ALL DISTURBED SURFACES OUTSIDE OF CRUSHED ROCK SURFACING TOP DRESSING.

12. ESC MEASURES SHALL BE REMOVED BY THE CONTRACTOR WHEN VEGETATION IS FULLY ESTABLISHED.

13. CONTRACTOR SHALL PROVIDE AND MAINTAIN A CONCRETE WASHOUT FACILITY.


TOPOGRAPHIC LINEWORK LEGEND

	EXISTING	PROPOSED	
WATERLINE	10"W	—— 12"DI W ——	MANHOLE
ELECTRICITY	—— — — Е— —— ——	——————————————————————————————————————	CLEAN-OUT
GAS		4"G	CATCH BASIN/FIELD INLET
TELEPHONE/TELEMETRY		T	THRUST BLOCK
CABLE TELEVISION	CATV	CATV	VALVE
SANITARY SEWER LINE	8"SS		AIR INJECTION ASSEMBLY
SANITARY SEWER FORCE MAIN	6"FM		BLOW-OFF ASSEMBLY
STORM DRAIN	8"SD		AIR RELEASE ASSEMBLY
CULVERT		≻18"D<	FIRE HYDRANT ASSEMBLY
ABANDON PIPE		<i>┥ ┽ ┼ ┼─/ ┥ ─</i>	WATER METER
DRAINAGE DITCH	· · · · · ·	· · · · · · · ·	PULL BOX/JUNCTION BOX
BARBWIRE FENCE	X	X	UTILITY POLE
CHAIN LINK FENCE	-0	$-\bigcirc$ $-\bigcirc$ $-\bigcirc$ $-\bigcirc$ $-\bigcirc$ $-\bigcirc$ $-\bigcirc$ $-\bigcirc$	GUY WIRE
SEDIMENT CONTROL LOG			LIGHT POST
GUARDRAIL	.0 0 0 0 0 00		MAILBOX
ROCK WALL			SIGN
TREE/BUSH LINE			BENCHMARK
CENTERLINE			TREE DECIDUOUS
BOULDER COUNTY SHADING			TREE CONIFEROUS
EASEMENT/PROPERTY LINE			RESTRAINED JOINT PIPE
RIGHT-OF-WAY			
EDGE OF PAVEMENT/AC	<u> </u>	en i 195 mer selle ister give die ste die gewen die ste het.	SURFACE ELEVATION
EDGE OF GRAVEL			
CURB			
SIDEWALK	S/₩	а. <u>А</u>	
STRUCTURE OR FACILITY			
CONTOUR MINOR			
CONTOUR MAJOR	200	200	

TOPOGRAPHIC SYMBOL LEGEND

SECTION AND DETAIL DESIGNATIONS


SECTION DESIGNATIONS

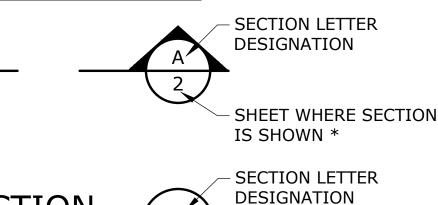



SHEET FROM WHICH SECTION IS TAKEN *

DETAIL DESIGNATIONS

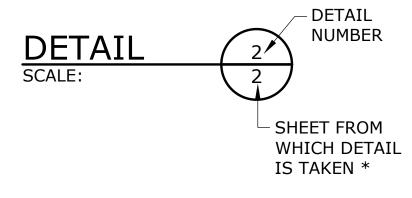

* NOTE: IF PLAN AND SECTION FOR DETAIL CALL-OUT AND DETAIL ARE SHOWN ON THE SAME DRAWING, DRAWING NUMBER IS REPLACED WITH A DASH.

PROPOSED
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+ 176.63



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STAIS ARCHITECTS. COM

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Review	5 may 2022
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bid clarification	30 june 2022
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CIVIL NOTES AND LEGEND

C001

@	AT
AASHTO	AMERICAN ASSOCIATION OF STATE
	HIGHWAY & TRANSPORTATION OFFICIALS
AB	ANCHOR BOLT
ABAN(D)	ABANDON(ED)
ABS	ACRYLONITRILE BUTADIENE STYRENE
ABV	ABOVE / ALCOHOL BY VOLUME
AC	ASPHALTIC CONCRETE
ACP	ASPHALTIC CONCRETE PAVING
ADJ	ADJUSTABLE
ADJC	ADJACENT
AFF	ABOVE FINISHED FLOOR
AFG	ABOVE FINISHED GRADE
AHR	ANCHOR
AL	ALUMINUM
ALT	ALTERNATE
AMP	AMPERE
ANSI	AMERICAN NATIONAL STANDARDS
-	APPROXIMATE
APPVD	APPROVED
APWA	AMERICAN PUBLIC WORKS ASSOCIATION
ARCH	ARCHITECTURAL
ARV	AIR RELEASE VALVE
ASCE	AMERICAN SOCIETY OF CIVIL ENGINEERS
ASSN	ASSOCIATION
ASSY	ASSEMBLY
ASTM	AMERICAN SOCIETY FOR TESTING
ATM	& MATERIALS ATMOSPHERE
AUTO	AUTOMATIC
AUX	AUXILIARY
AVE	AVENUE
AVG	AVERAGE
AWWA	AMERICAN WATER WORKS ASSOCIATION
B&S	BELL & SPIGOT
BC	BOLT CIRCLE
BD	BOARD
BETW	BETWEEN
BF	BOTH FACE
BFD	BACKFLOW PREVENTION DEVICE
BFILL	BACKFILL
BFV	BUTTERFLY VALVE
BHP	BRAKE HORSEPOWER
BKGD BLDG	BUILDING
BLK	BLOCK
BLVD	BOULEVARD
BM	BENCHMARK / BEAM
BMP	BEST MANAGEMENT PRACTICES
BO	BLOW-OFF
BOC	BACK OF CURB
BS	BOTH SIDES
BSMT	BASEMENT
BTF	BOTTOM FACE
BTU	BRITISH THERMAL UNIT
BV	BALL VALVE
BW	BOTH WAYS
С	CELSIUS
	CENTER TO CENTER COMBINATION AIR RELEASE VALVE
CATV	CABLE TELEVISION
CB	CATCH BASIN
CCP	CONCRETE CYLINDER PIPE
CCW	COUNTER CLOCKWISE
CDOT	COLORADO DEPARTMENT OF
CFM	TRANSPORTATION CUBIC FEET PER MINUTE
CFS	CUBIC FEET PER SECOND
CHAN	CHANNEL
CHEM	CHEMICAL
CHKV	CHAMFER CHECK VALVE
CI	CAST IRON
CIP	CAST IRON PIPE
CIPC	CAST IN PLACE CONCRETE CAST IRON SOIL PIPE
CJ	CONSTRUCTION JOINT
CL OR C/L	CENTER LINE
CL2	CHLORINE
CLG	CEILING
CLJ	CONTROL JOINT
CLR	CLEAR
CLSM	CONTROLLED LOW STRENGTH MATERIAL
CMP	CORRUGATED METAL PIPE

CMU CND CO COL COMB CONC CONN CONST CONTR CONTR COORD COP CORP CORR CP CORR CP CORR CP CORR CP CORR CP CORP COR	CONCRETE MASONRY UNIT CONDUIT CLEANOUT COLUMN COMBINATION CONSTRUCTION CONCRETE CONNECTION CONSTRUCTION CONTINUOUS / CONTINUATION CONTRACT(OR) COORDINATE COPPER CORPORATION CORRUGATED CONTROL POINT COUPLING CHLORINATED POLYVINYL CHLORIDE CRUSHED ROCK COMBINED SEWER CONCRETE SEWER PIPE COURT CENTER CUBIC CULVERT CONTROL VALVE CLOCKWISE / COLD WATER CUBIC YARDS CYLINDER LOCK
D DC DEFL DET DI DIA DIA DIM DIR DIST DN DR DS DWG DWL DWV DWV	DRAIN DIRECT CURRENT DEFLECTION DETAIL DUCTILE IRON DIAMETER DIMENSION DIRECTION DISTANCE DOWN DRIVE DOWNSPOUT DRAWING DOWEL DRAIN WASTE AND VENT DRIVEWAY
EA ECC EF EL ELB ENCL EOG EOP EQ EQL SP EQUIP ESMT ESMT EXP EXC EXIST EXP EXP BT EXP JT	EDGE OF GRAVEL, EDGE OF GRADING EDGE OF PAVEMENT EQUAL EQUALLY SPACED
F TO F FAB FB	FLOOR DRAIN FOUNDATION FIRE EXTINGUISHER FAR FACE FIBERGLASS FIRE HYDRANT FINISH(ED)

FOF	FACE OF FINISH	L	LENGTH	PSPT	PIPE SUPPORT
FOM	FACE OF MASONRY	LAB	LABORATORY	PT	POINT OF TAN
FOS	FACE OF STUDS	LAV LB	LAVATORY POUND	PTVC	POINT OF TAN
FPM FPS	FEET PER MINUTE FEET PER SECOND	LF	LINEAR FOOT	PV	CURVE PLUG VALVE
FRP	FIBERGLASS REINFORCED PLASTIC	LIN	LINEAL	PVC	POLYVINYL CH
FT	FEET / FOOT	LN	LANE	PVMT	PAVEMENT
FTG	FOOTING	LOC	LOCATION	PWR	POWER
FUT	FUTURE	LONG LP			
FXTR	FIXTURE	LP LPT	LOW PRESSURE LOW POINT	QTY	QUANTITY
G	GAS	LRG	LARGE	RAD	RADIUS
GA	GAUGE	LS	LONG SLEEVE / LUMP SUM	RC	REINFORCED
GAL	GALLON	LT	LEFT	RCP	REINFORCED
GALV	GALVANIZED	LVL		RD	ROAD / ROOF
GC	GROOVED COUPLING	LWL	LOW WATER LINE	RDCR	REDUCER
GFA GI	GROOVED FLANGE ADAPTER GALVANIZED IRON	MAN	MANUAL	REF REINF	REFERENCE REINFORCE(D
GIP	GALVANIZED IRON PIPE	MAT	MATERIAL	REQ'D	REQUIRED
GJ	GRIP JOINT	MAX	MAXIMUM	RESTR	RESTRAINED
GL	GLASS	MCC	MOTOR CONTROL CENTER	RFCA	RESTRAINED F
GLV	GLOBE VALVE	MCP MECH	MASTER CONTROL PANEL MECHANICAL		ADAPTER
GND		MET	METAL	RM	ROOM
GPD GPH	GALLONS PER DAY GALLONS PER HOUR	MFR	MANUFACTURER	RND RO	ROUND ROUGH OPENI
GPM	GALLONS PER MINUTE	MGD	MILLION GALLONS PER DAY	R/W	RIGHT-OF-WA
GPS	GALLONS PER SECOND	MH	MANHOLE	, RPBPD	REDUCED PRE
GR	GRADE	MIN			PREVENTION [
GR LN	GRADE LINE	MIPT MISC	MALE IRON PIPE THREAD MISCELLANEOUS	RPM	REVOLUTIONS
GRTG	GRATING GATE VALVE	MJ	MECHANICAL JOINT	RR	RAILROAD
GV GRVL	GATE VALVE GRAVEL	MON	MONUMENT / MONOLITHIC	RST RT	REINFORCED S RIGHT
GYP	GYPSUM	MOT	MOTOR		NIGHT
		MP	MILEPOST	SALV	SALVAGE
HB	HOSE BIBB	MSL MTD	MEAN SEAL LEVEL MOUNTED	SAN	SANITARY
HC	HOLLOW CORE	MID	MOUNTED	SC	SOLID CORE
HDPE HDR	HIGH DENSITY POLYETHYLENE HEADER	NA	NOT APPLICABLE	SCHED SD	SCHEDULE STORM DRAIN
HDWE	HARDWARE	NC	NORMALLY CLOSED	SDL	SADDLE
HGR	HANGER	NF	NEAR FACE	SDR	STANDARD DI
HGT	HEIGHT	NIC		SECT	SECTION
HH	HANDHOLD	NO / NO. NOM	NORMALLY OPEN / NUMBER NOMINAL	SHLDR	SHOULDER
HM HMAC	HOLLOW METAL HOT MIX ASPHALT CONCRETE	NORM	NORMAL	SHT SIM	SHEET
HNDRL	HANDRAIL	NRS	NON-RISING STEM	SLP	SIMILAR SLOPE
HOA	HAND-OFF-AUTO	NTS	NOT TO SCALE	SLV	SLEEVE
HOR	HAND-OFF-REMOTE			SOLN	SOLUTION
HORIZ	HORIZONTAL	0 то о		SP	SOIL PIPE / SE
HP	HIGH PRESSURE / HORSEPOWER	OC OD	ON CENTER OUTSIDE DIAMETER	SPCL	SPECIAL
HPG HPT	HIGH PRESSURE GAS HIGH POINT	OF	OVERFLOW / OUTSIDE FACE	SPEC(S) SPG	SPECIFICATIO SPACING
HR	HOUR	OPNG	OPENING	SPG	SPOOL
HSB	HIGH STRENGTH BOLT	OPP	OPPOSITE	SPRT	SUPPORT
HV	HOSE VALVE	ORIG	ORIGINAL	SQ	SQUARE
HVAC	HEATING, VENTILATION, AIR	OVHD	OVERHEAD	SQ FT	SQUARE FOOT
HWL	CONDITIONING HIGH WATER LINE	P&ID	PROCESS & INSTRUMENTATION	SQ IN	SQUARE INCH
HWY	HIGHWAY	-	DIAGRAM	SQ YD SS	SQUARE YARD SANITARY SEV
HYD	HYDRANT	PC	POINT OF CURVE	SST	STAINLESS ST
HYDR	HYDRAULIC	PCC	POINT OF COMPOUND CURVE	ST	STREET
		PCVC	POINT OF CURVATURE ON VERTICAL CURVE	STA	STATION
I&C	INSTRUMENTATION & CONTROL	PE	PLAIN END	STD	STANDARD
IAW ID	IN ACCORDANCE WITH INSIDE DIAMETER	PERF	PERFORATED	STL STOR	STEEL STORAGE
IE	INVERT ELEVATION	PERM	PERMANENT	STR	STRAIGHT
IF	INSIDE FACE	PERP	PERPENDICULAR	STRUCT	STRUCTURE /
IMPVT	IMPROVEMENT	PG PH	PRESSURE GAUGE PIPE HANGER	SUBMG	SUBMERGED
IN		PI	POINT OF INTERSECTION	SUCT	SUCTION
INCC INFL	INCLUDE(D)(ING) INFLUENT	PIVC	POINT OF INTERSECTION ON	SV S/W	SOLENOID VA SIDEWALK
INJ	INJECTION		VERTICAL CURVE	S/W SWD	SIDEWALK
INSTL	INSTALLATION / INSTALL	PL OR P/L		SWGR	SWITCH GEAR
INSUL	INSULATION	PLBG	PLUMBING	SYMM	SYMMETRICAL
INTER	INTERCEPTOR	PNL POC	PANEL POINT OF CURVATURE	SYS	SYSTEM
		POLY	POLYETHYLENE		
INV IP	INVERT IRON PIPE	PP	POWER POLE	T OR TEL T&B	TELEPHONE TOP & BOTTO
IP IPT	IRON PIPE IRON PIPE THREAD	PRC	POINT OF REVERSE CURVATURE	TAN	TANGENCY
IR	IRON ROD	PRCST	PRECAST	TB	THRUST BLOC
IRRIG	IRRIGATION	PREP	PREPARATION	TBM	TEMPORARY B
		PRESS PRKG	PRESSURE PARKING	ТС	TOP OF CONC
JT		PRKG PROP	PARKING PROPERTY / PROPOSED	TCE	TEMPORARY C
JUNC	JUNCTION	PROP	PRESSURE REDUCING VALVE	דטי	EASEMENT
KPL	KICK PLATE	PS	PUMP STATION	TDH TEMP	TOTAL DYNAM
KVA	KILOVOLT AMPERE	PSIG	POUNDS PER SQUARE INCH GAUGE	T&G	TONGUE & GR
KW	KILOWATT	PSL	PIPE SLEEVE	THK	THICK / THICK
KWY	KEYWAY			THRD	THREAD (ED)
				THRU	THROUGH
	•				

ΤP ORT TANGENCY TANGENCY ON VERTICAL TSP TST L CHLORIDE ΤW TYP UG UH UN UON CED CONCRETE USGS CED CONCRETE PIPE OOF DRAIN V VAC VB VBOX CE(D)(ING)(MENT) VC VERT ED IED FLANGE COUPLING VFD VOL VCP VTR PENING W -WAY PRESSURE BACKFLOW W/ ON DEVICE W/IN ONS PER MINUTE W/O W/W CED STEEL WD WF WH WI WM WP WS RAIN WΤ WTP DIMENSION RATIO WTRT WWF XFMR / SEWER PIPE YD ΥH YR ATION(S) ΖN OOT NCH ARD SEWER S STEEL RE / STRUCTURAL ED D VALVE ER DEPTH EAR [CAL ттом BLOCK RY BENCHMARK ONCRETE / TOP OF CURB RY CONSTRUCTION NAMIC HEAD URE / TEMPORARY k GROOVE HICKNESS ED)

TEST PIT / TOP OF PAVEMENT / TURNING POINT TRANS TRANSITION TRI-SODIUM PHOSPHATE TOP OF STEEL TOP OF WALL TYPICAL UNDERGROUND UNIT HEATER UNION UNLESS OTHERWISE NOTED UNITED STATES GEOLOGIC SURVEY VENT / VOLT VACUUM VACUUM BREAKER VALVE BOX VERTICAL CURVE VERTICAL VARIABLE FREQUENCY DRIVE VOLUME VITRIFIED CLAY PIPE VENT THROUGH ROOF WATER WITH WITHIN WITHOUT WALL TO WALL WOOD WIDE FLANGE WATER HEATER WROUGHT IRON WATER METER WORKING POINT / WATERPROOFING WATER SERVICE WEIGHT WATER TREATMENT PLANT WATERTIGHT WELDED WIRE FABRIC WWTF WASTEWATER TREATMENT FACILITY WWTP WASTEWATER TREATMENT PLANT X SECT CROSS SECTION TRANSFORMER YARD DRAIN / YARD YARD HYDRANT YEAR ZINC



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> 277 marina road frisco . colorado

PROJECT # 2161


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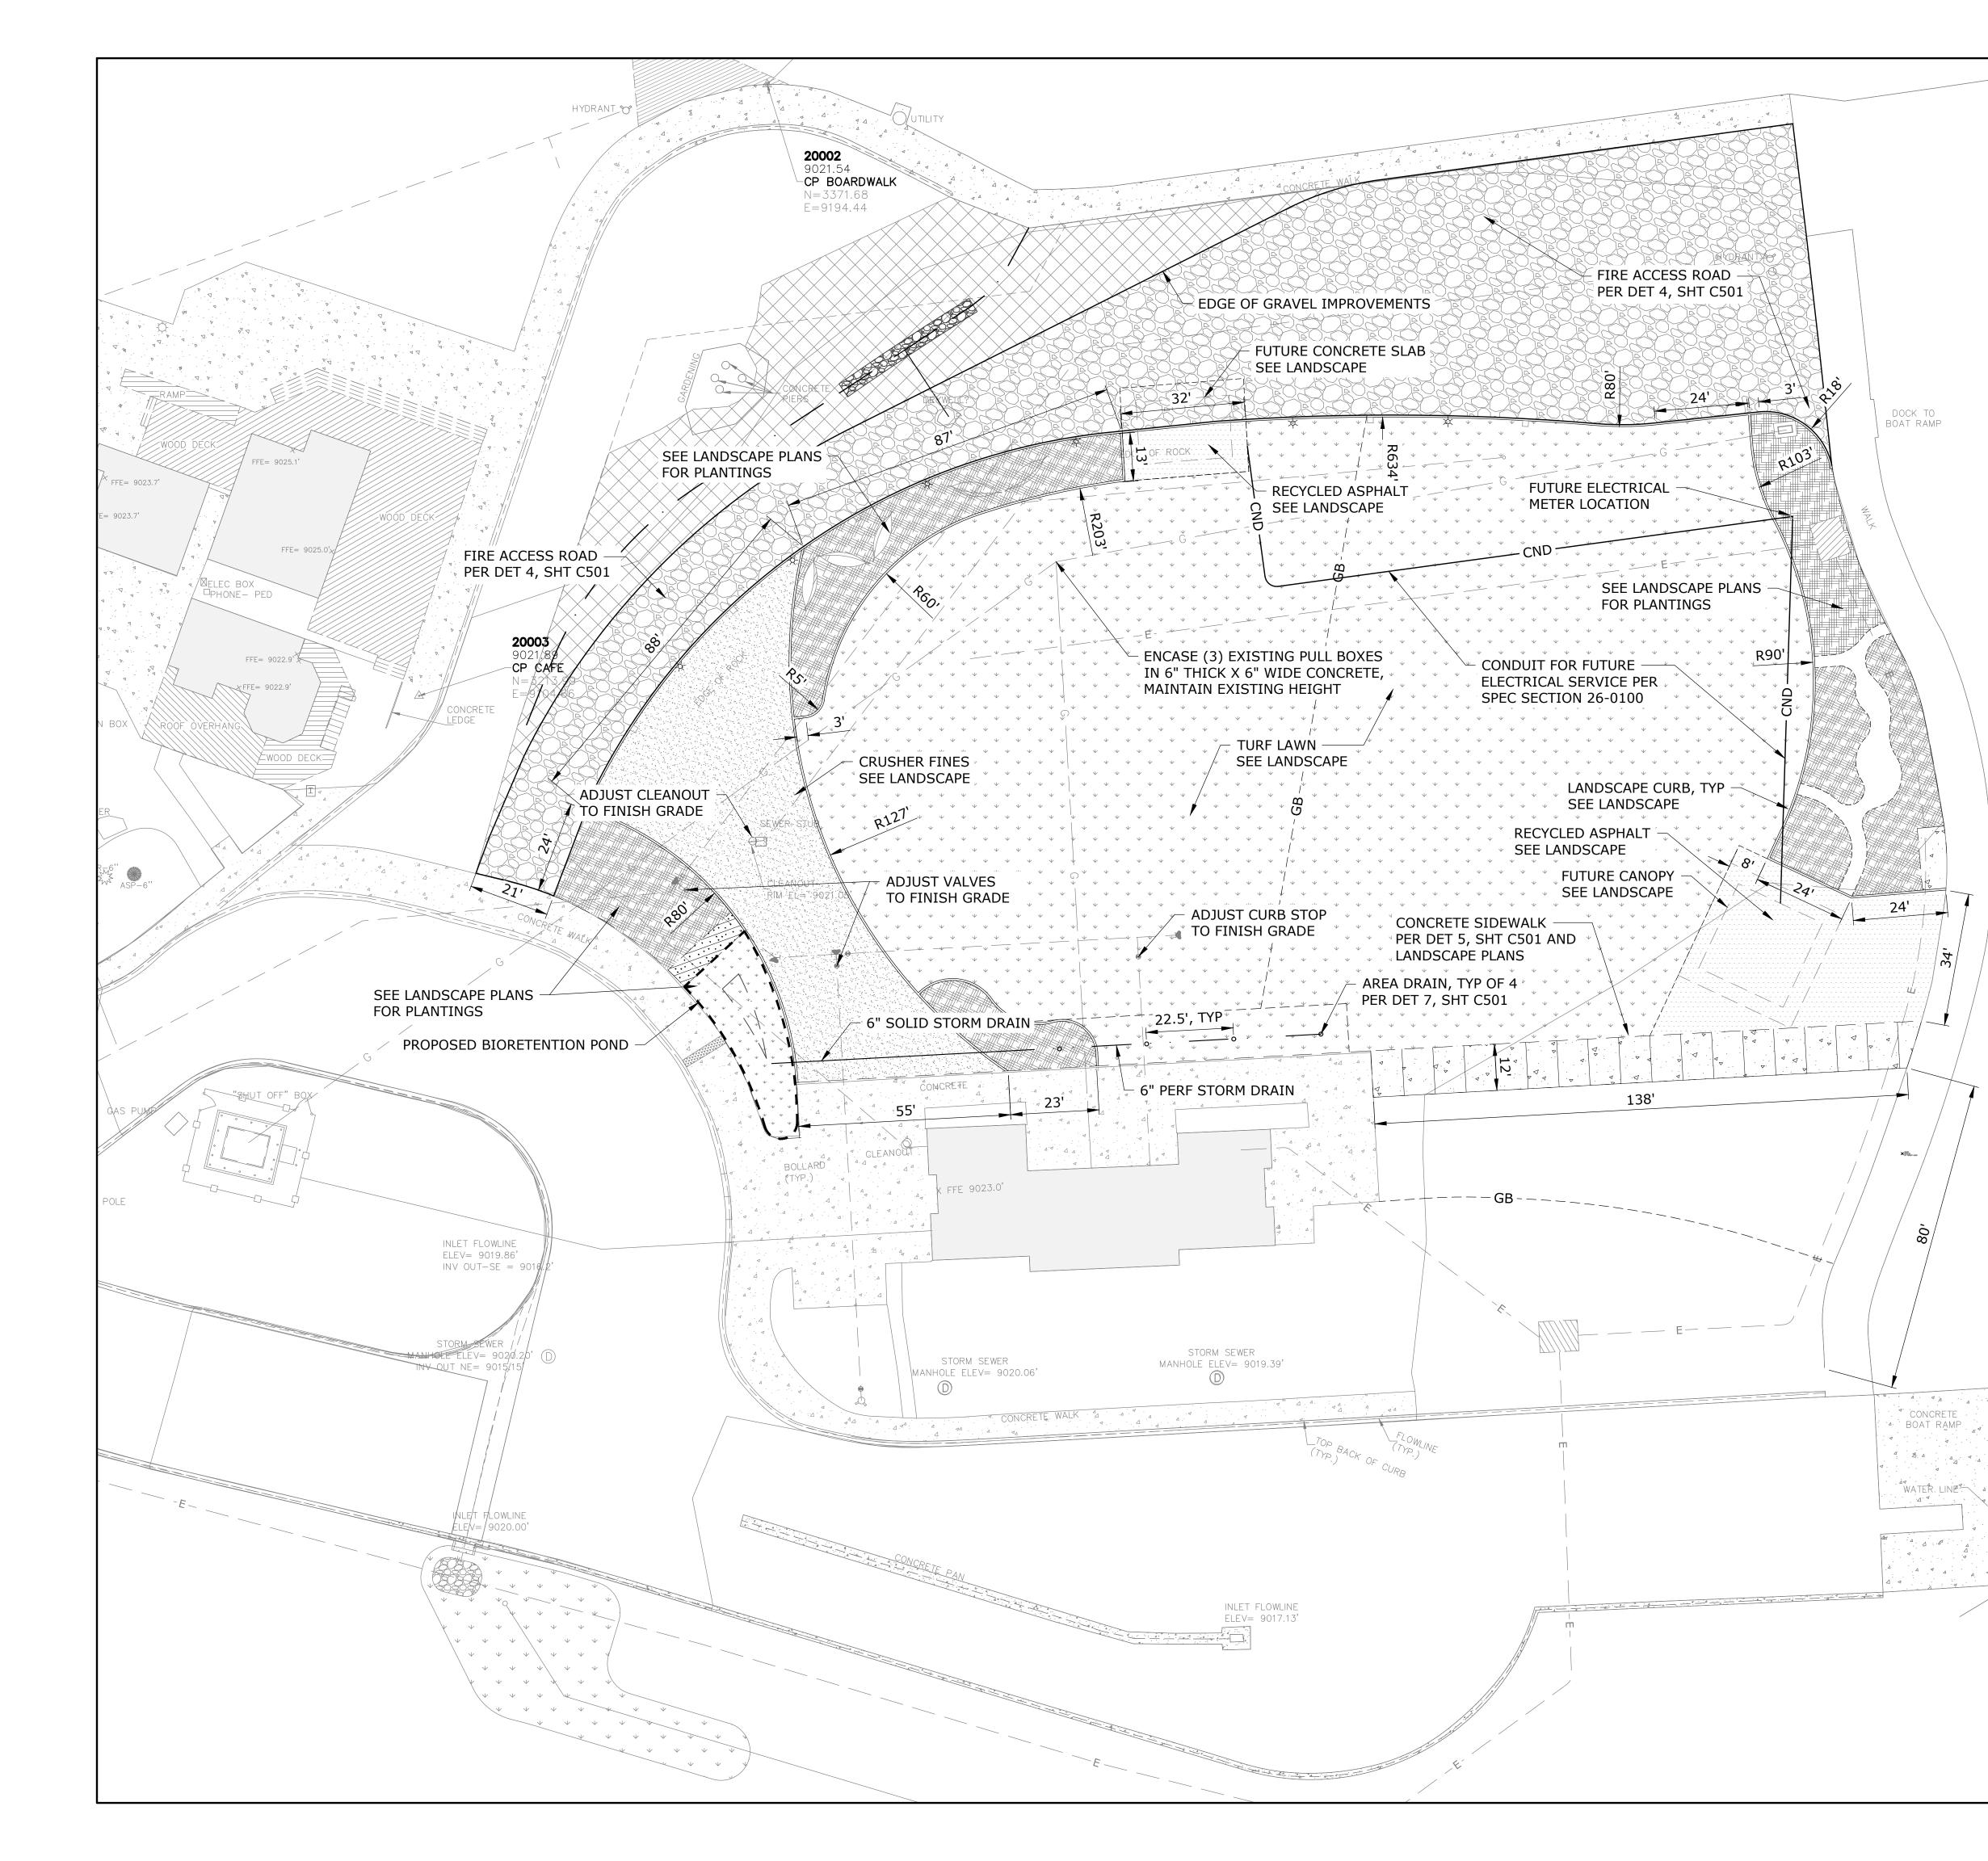
ISSUE:

Review	5 may 2022
bid set	24 may 2022
bid clarification	30 june 2022
bid documents	19 sept 2022

CIVIL ABBREVIATIONS

C002



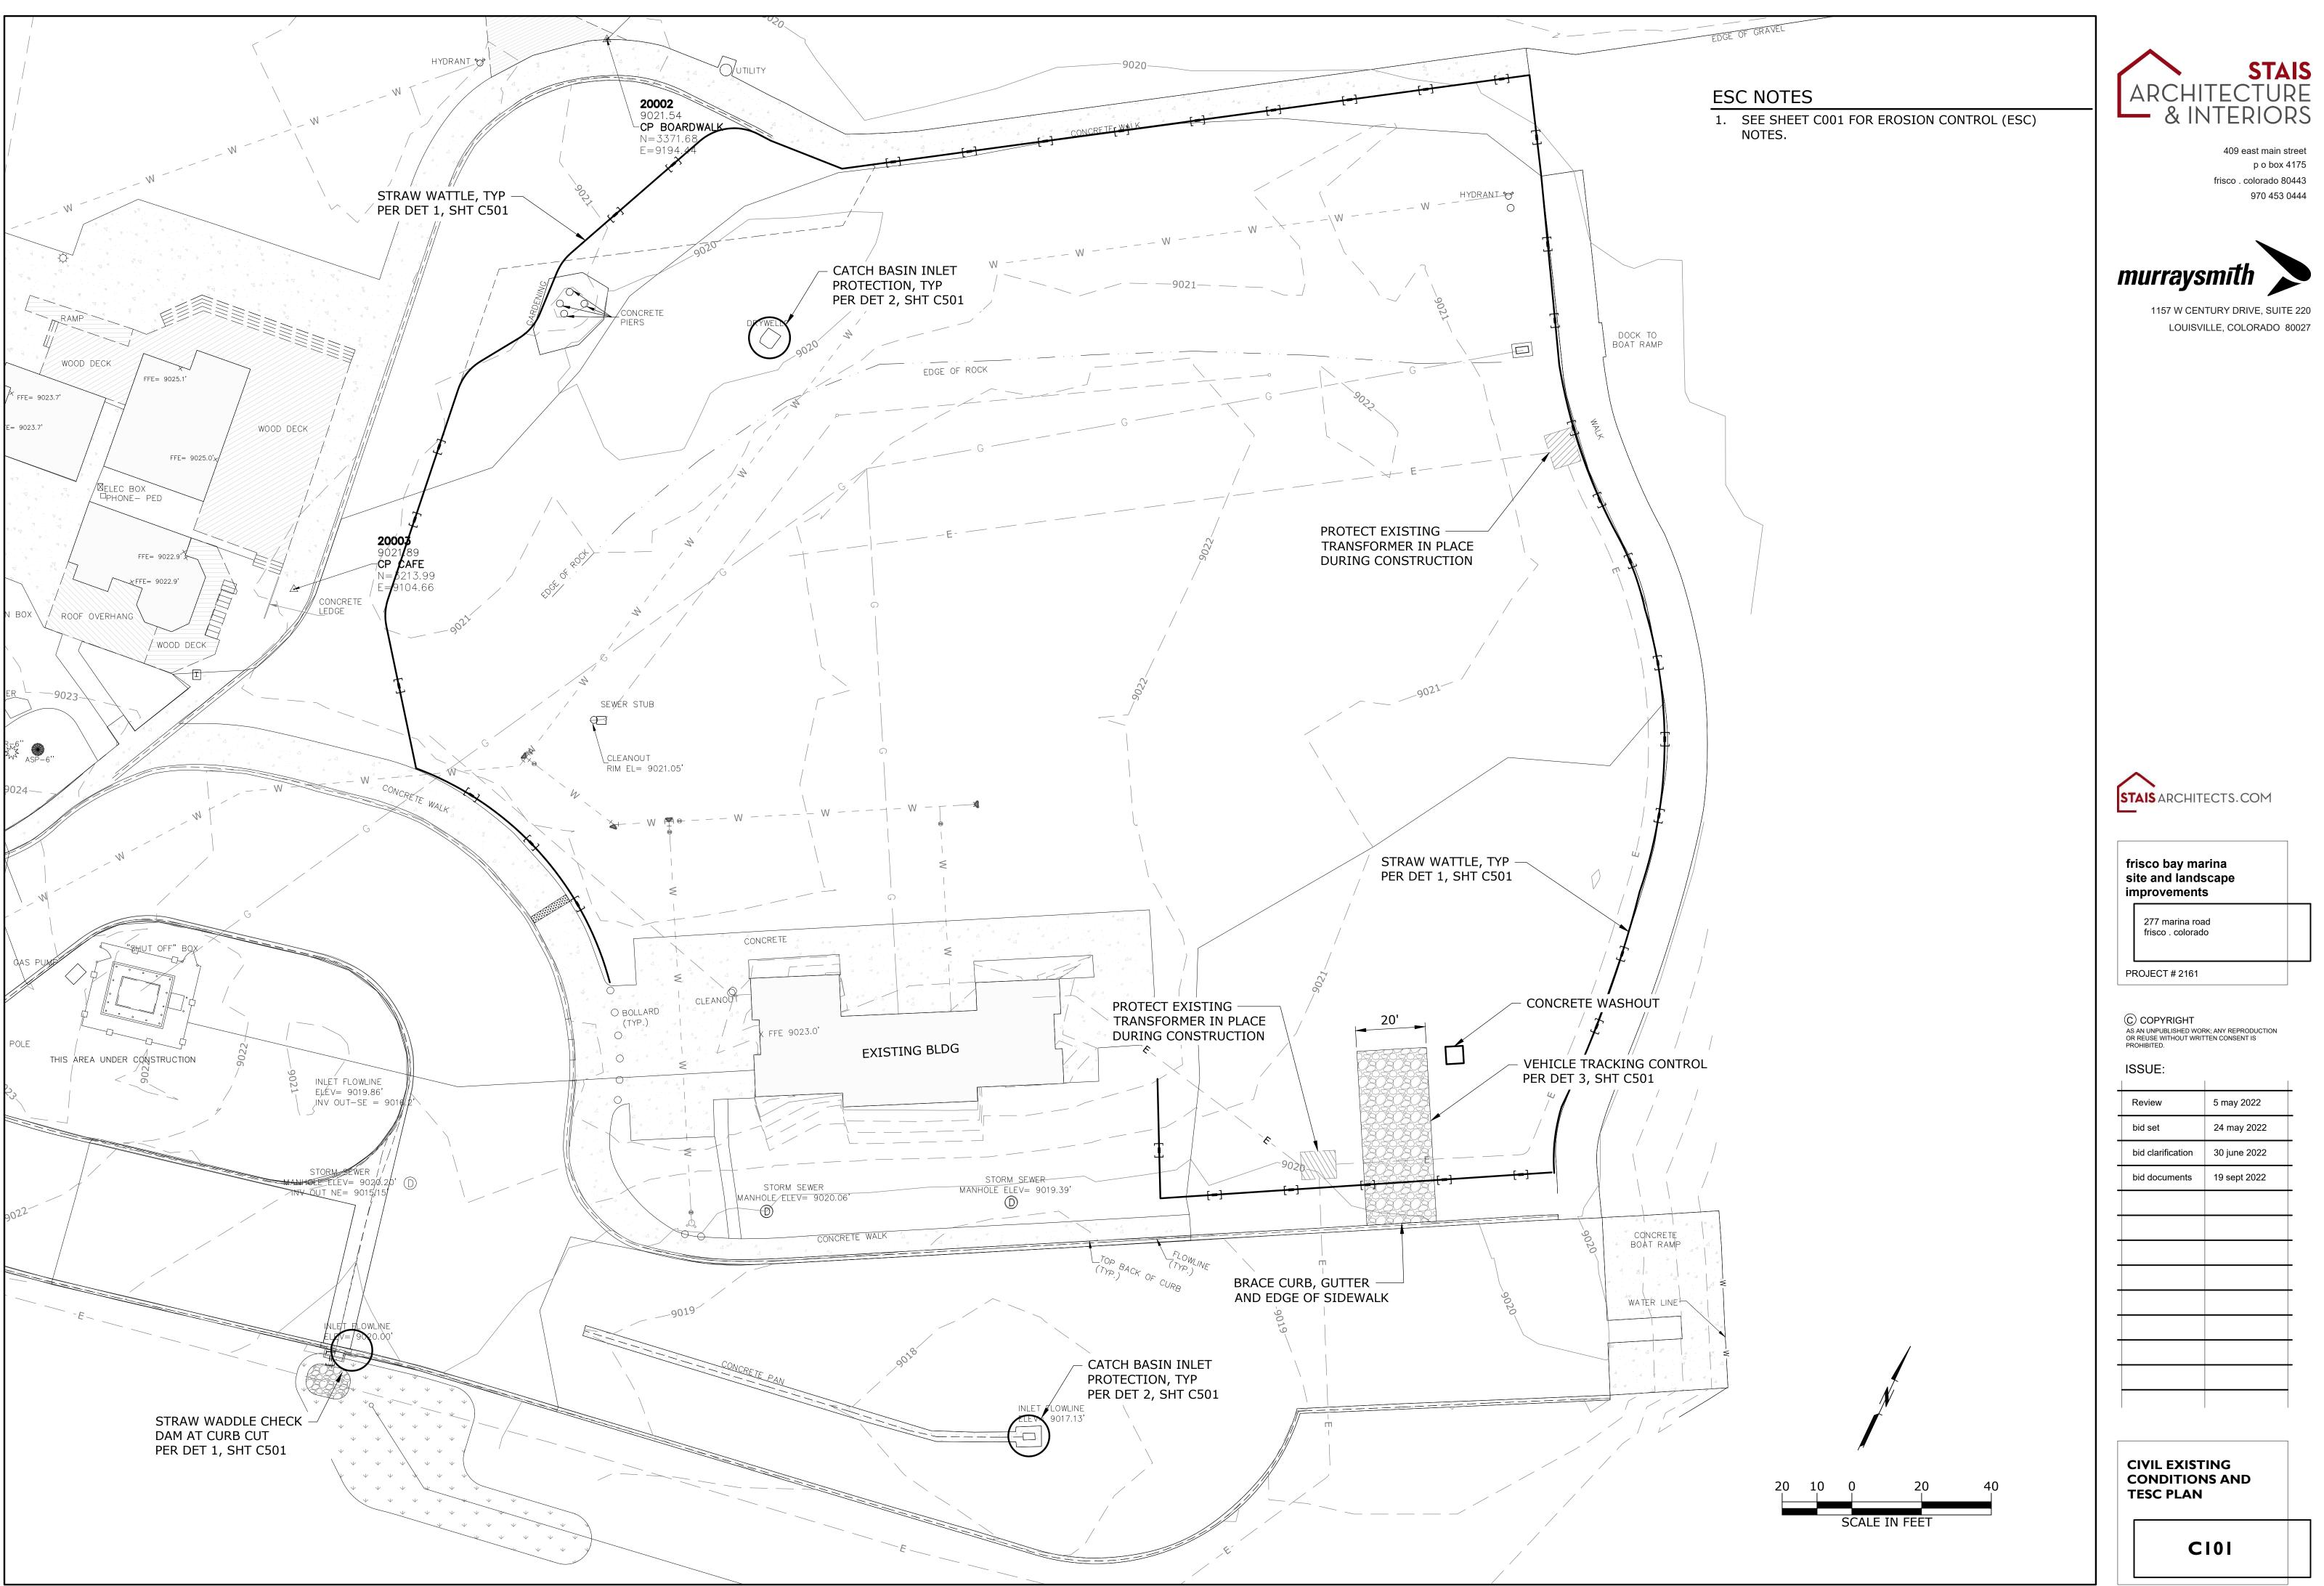

SITE GENERAL NOTES

- 1. DIMENSIONS SHOWN FOR REFERENCE ONLY. SEE LANDSCAPE PLANS FOR FINAL DIMENSIONS ASSOCIATED WITH SITE FEATURES.
- 2. THE LOCATIONS OF ALL EXISTING UNDERGROUND FACILITIES SHOWN ON THE PLANS ARE BASED ON A FIELD SURVEY AND SITE OBSERVATIONS. LOCATIONS ARE NOT GUARANTEED TO BE COMPLETE OR ACCURATE. CONTRACTOR SHALL NOTIFY ENGINEER IMMEDIATELY OF ANY CONFLICTS AND SHALL KEEP EXISTING UTILITIES IN SERVICE AND PROTECT THEM DURING CONSTRUCTION. WHERE INTERRUPTION OF EXISTING FACILITIES IS REQUIRED, CONTRACTOR SHALL PROVIDE 72 HOUR NOTICE TO ENGINEER AND THE AFFECTED UTILITY.
- 3. THE CONTRACTOR SHALL RESTORE ALL STRUCTURES, LOTS, SWALES, DITCHES, CURBS, FENCES, WALLS, MAILBOXES, SIGNS, POLES, GUY WIRES, PIPING, AND UTILITIES DISTURBED DURING CONSTRUCTION TO EXISTING CONDITION UNLESS OTHERWISE SPECIFIED.
- 4. THE CONTRACTOR SHALL PROTECT TRAFFIC AT ALL TIMES DURING CONSTRUCTION. ALL TRAFFIC CONTROL MEASURES SHALL BE APPROVED BY THE OWNER AS REQUIRED AND IN PLACE PRIOR TO ANY CONSTRUCTION ACTIVITIES. THE CONTRACTOR SHALL PROVIDE TRAFFIC CONTROL PLANS TO THE OWNER PRIOR TO COMMENCING ANY WORK.
- 5. CONTRACTOR TO PROVIDE VISIBLE SITE FENCING/CONSTRUCTION FENCING AS NECESSARY TO DIRECT THE PUBLIC AWAY FROM THE CONSTRUCTION SITE.
- 6. THE CONTRACTOR SHALL VERIFY ALL CONDITIONS AND DIMENSIONS ON THE JOB SITE AND SHALL NOTIFY THE ENGINEER OF ANY DIMENSIONAL ERRORS, OMISSIONS OR DISCREPANCIES BEFORE BEGINNING OR FABRICATING WORK.

SCALE IN FEE



409 east main street p o box 4175 frisco . colorado 80443 970 453 0444



1157 W CENTURY DRIVE, SUITE 220 LOUISVILLE, COLORADO 80027



STAIS ARCHITECTS. COM

frisco bay marina site and landscape improvements

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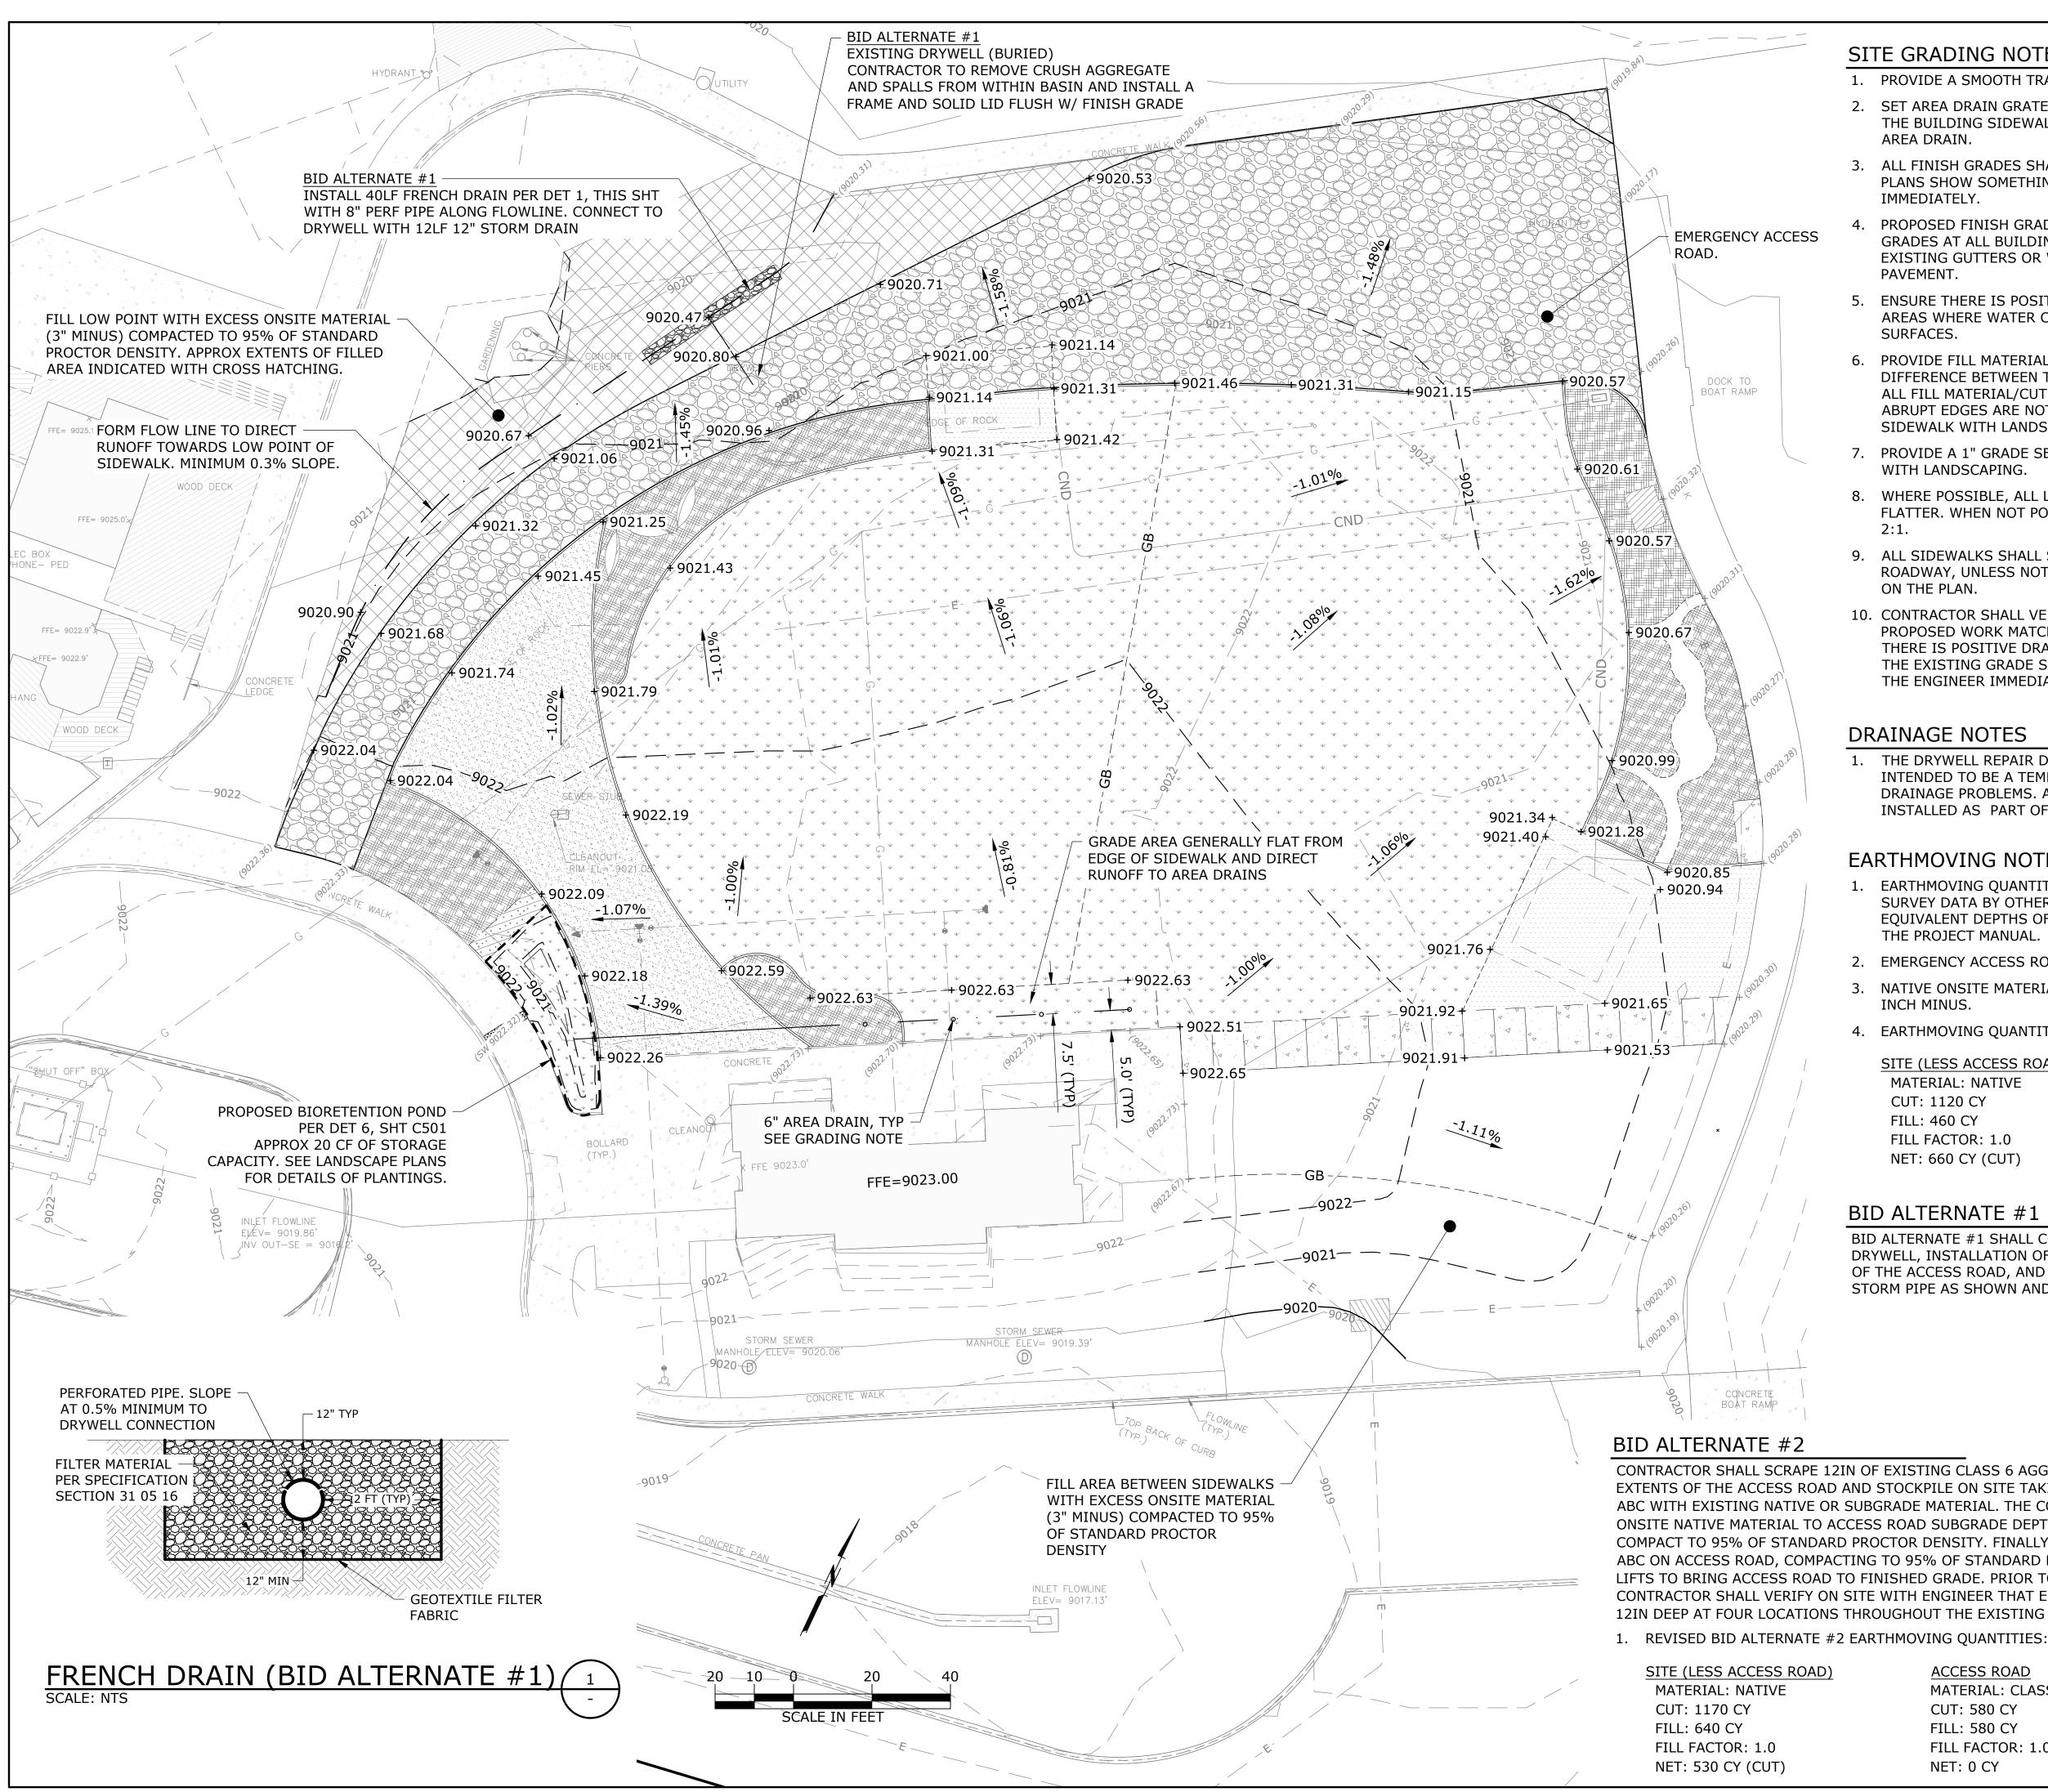
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CIVIL SITE PLAN

C102



SITE GRADING NOTES

- PROVIDE A SMOOTH TRANSITION FOR ALL SITE GRADING
- 2. SET AREA DRAIN GRATES 3" BELOW THE EXISTING ELEVATION OF THE BUILDING SIDEWALK. ENSURE POSITIVE DRAINAGE TO THE AREA DRAIN.
- 3. ALL FINISH GRADES SHALL SLOPE AWAY FROM BUILDINGS. IF PLANS SHOW SOMETHING DIFFERENT NOTIFY THE ENGINEER IMMEDIATELY.
- PROPOSED FINISH GRADES SHALL BE FLUSH WITH EXISTING 4. GRADES AT ALL BUILDING ENTRANCES, EXISTING SIDEWALKS, EXISTING GUTTERS OR WHERE NEW PAVEMENT ABUTS EXISTING PAVEMENT.
- ENSURE THERE IS POSITIVE DRAINAGE AND THAT THERE ARE NO AREAS WHERE WATER CAN POOL ALONG THE PAVED/GRAVEL SURFACES.
- PROVIDE FILL MATERIAL/CUT, WHERE THERE IS A GRADE DIFFERENCE BETWEEN THE PROPOSED AND EXISTING GRADES. ALL FILL MATERIAL/CUT SHOULD CREATE A SMOOTH TRANSITION. ABRUPT EDGES ARE NOT ACCEPTABLE, SUCH AS AT BACK OF SIDEWALK WITH LANDSCAPING.
- PROVIDE A 1" GRADE SEPARATION AT ALL EDGE OF SIDEWALKS WITH LANDSCAPING.
- 8. WHERE POSSIBLE, ALL LANDSCAPE SLOPING SHOULD BE 4:1 OR FLATTER. WHEN NOT POSSIBLE THE SLOPE SHALL NOT EXCEED 2:1.
- 9. ALL SIDEWALKS SHALL SLOPE TOWARDS THE PARKING OR ROADWAY, UNLESS NOTED OTHERWISE FROM ELEVATIONS SHOWN ON THE PLAN.
- 10. CONTRACTOR SHALL VERIFY ELEVATIONS AT AREAS WHERE THE PROPOSED WORK MATCHES THE EXISTING GRADE TO ENSURE THERE IS POSITIVE DRAINAGE. IF THERE IS A DISCREPANCY IN THE EXISTING GRADE SHOWN THE CONTRACTOR SHALL NOTIFY THE ENGINEER IMMEDIATELY.

DRAINAGE NOTES

1. THE DRYWELL REPAIR DESCRIBED IN THESE PLANS IS ONLY INTENDED TO BE A TEMPORARY FIX TO IMPROVED KNOWN DRAINAGE PROBLEMS. A PERMANENT STORM SYSTEM SHALL BE INSTALLED AS PART OF FUTURE DEVELOPMENT OF THE PROPERTY

EARTHMOVING NOTES

- 1. EARTHMOVING QUANTITIES ARE APPROXIMATE AND BASED ON SURVEY DATA BY OTHERS AND DEPTHS TO SUBGRADE AND EQUIVALENT DEPTHS OF SOIL AMENDMENTS AS DESCRIBED IN THE PROJECT MANUAL.
- 2. EMERGENCY ACCESS ROAD SHALL BE FILLED WITH CLASS 6 ABC.
- 3. NATIVE ONSITE MATERIAL USED AS FILL SHALL BE SCREENED TO 3 INCH MINUS.
- 4. EARTHMOVING QUANTITIES:

SITE (LESS ACCESS ROAD) MATERIAL: NATIVE CUT: 1120 CY FILL: 460 CY FILL FACTOR: 1.0 NET: 660 CY (CUT)

ACCESS ROAD MATERIAL: CLASS 6 ABC CUT: 50 CY FILL: 185 CY FILL FACTOR: 1.0 NET: 135 CY (FILL)

BID ALTERNATE #1

BID ALTERNATE #1 SHALL CONSIST OF THE REPAIR OF THE EXISTING DRYWELL, INSTALLATION OF THE FRENCH DRAIN TO THE NORTHWEST OF THE ACCESS ROAD, AND AND INSTALLATION OF THE CONNECTING STORM PIPE AS SHOWN AND DESCRIBED ON THE PLANS.

CONTRACTOR SHALL SCRAPE 12IN OF EXISTING CLASS 6 AGGREGATE BASE COURSE FROM FULL EXTENTS OF THE ACCESS ROAD AND STOCKPILE ON SITE TAKING CARE TO NOT MIX OR CONTAMINATE ABC WITH EXISTING NATIVE OR SUBGRADE MATERIAL. THE CONTRACTOR SHALL THEN PLACE EXCESS ONSITE NATIVE MATERIAL TO ACCESS ROAD SUBGRADE DEPTH (12IN BELOW FINISHED GRADE) AND COMPACT TO 95% OF STANDARD PROCTOR DENSITY. FINALLY CONTRACTOR SHALL PLACE STOCKPILED ABC ON ACCESS ROAD, COMPACTING TO 95% OF STANDARD PROCTOR DENSITY IN 8IN MAXIMUM LOOSE LIFTS TO BRING ACCESS ROAD TO FINISHED GRADE. PRIOR TO ANY INITIAL REMOVAL OF ABC, CONTRACTOR SHALL VERIFY ON SITE WITH ENGINEER THAT EXISTING ABC DEPTH IS A MINIMUM OF 12IN DEEP AT FOUR LOCATIONS THROUGHOUT THE EXISTING ACCESS ROAD.

ACCESS ROAD MATERIAL: CLASS 6 ABC CUT: 580 CY FILL: 580 CY FILL FACTOR: 1.0 NET: 0 CY



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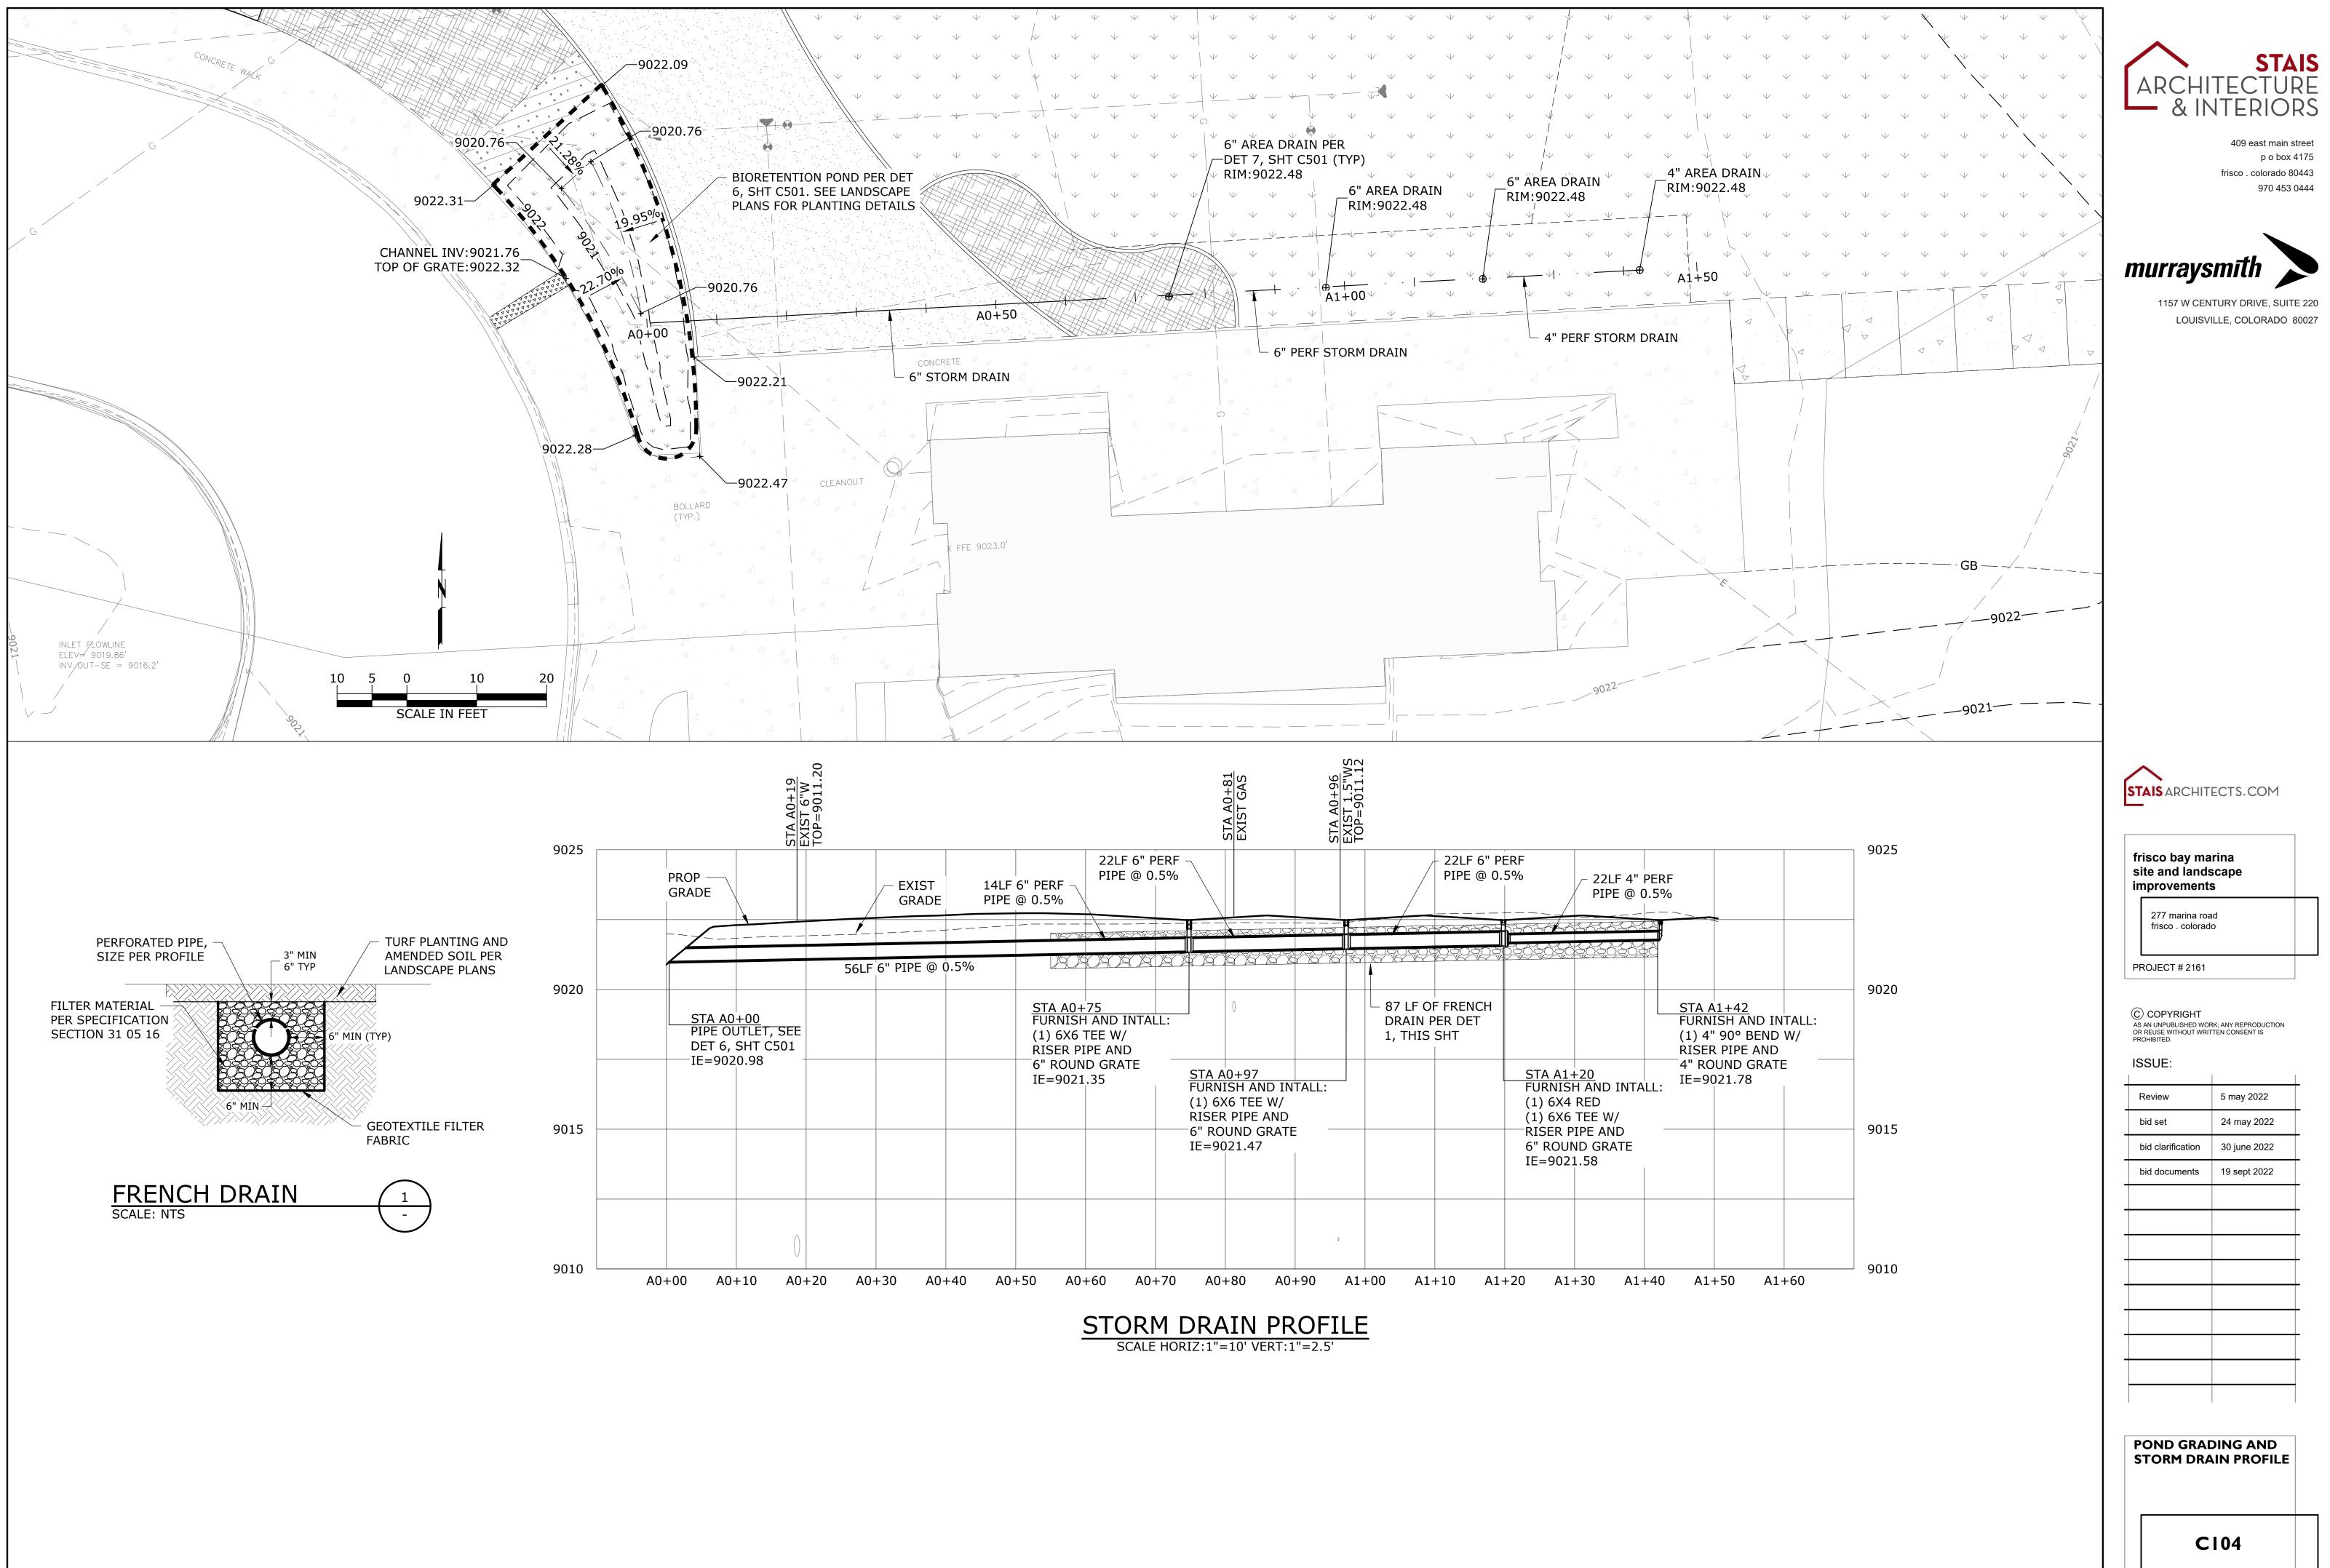
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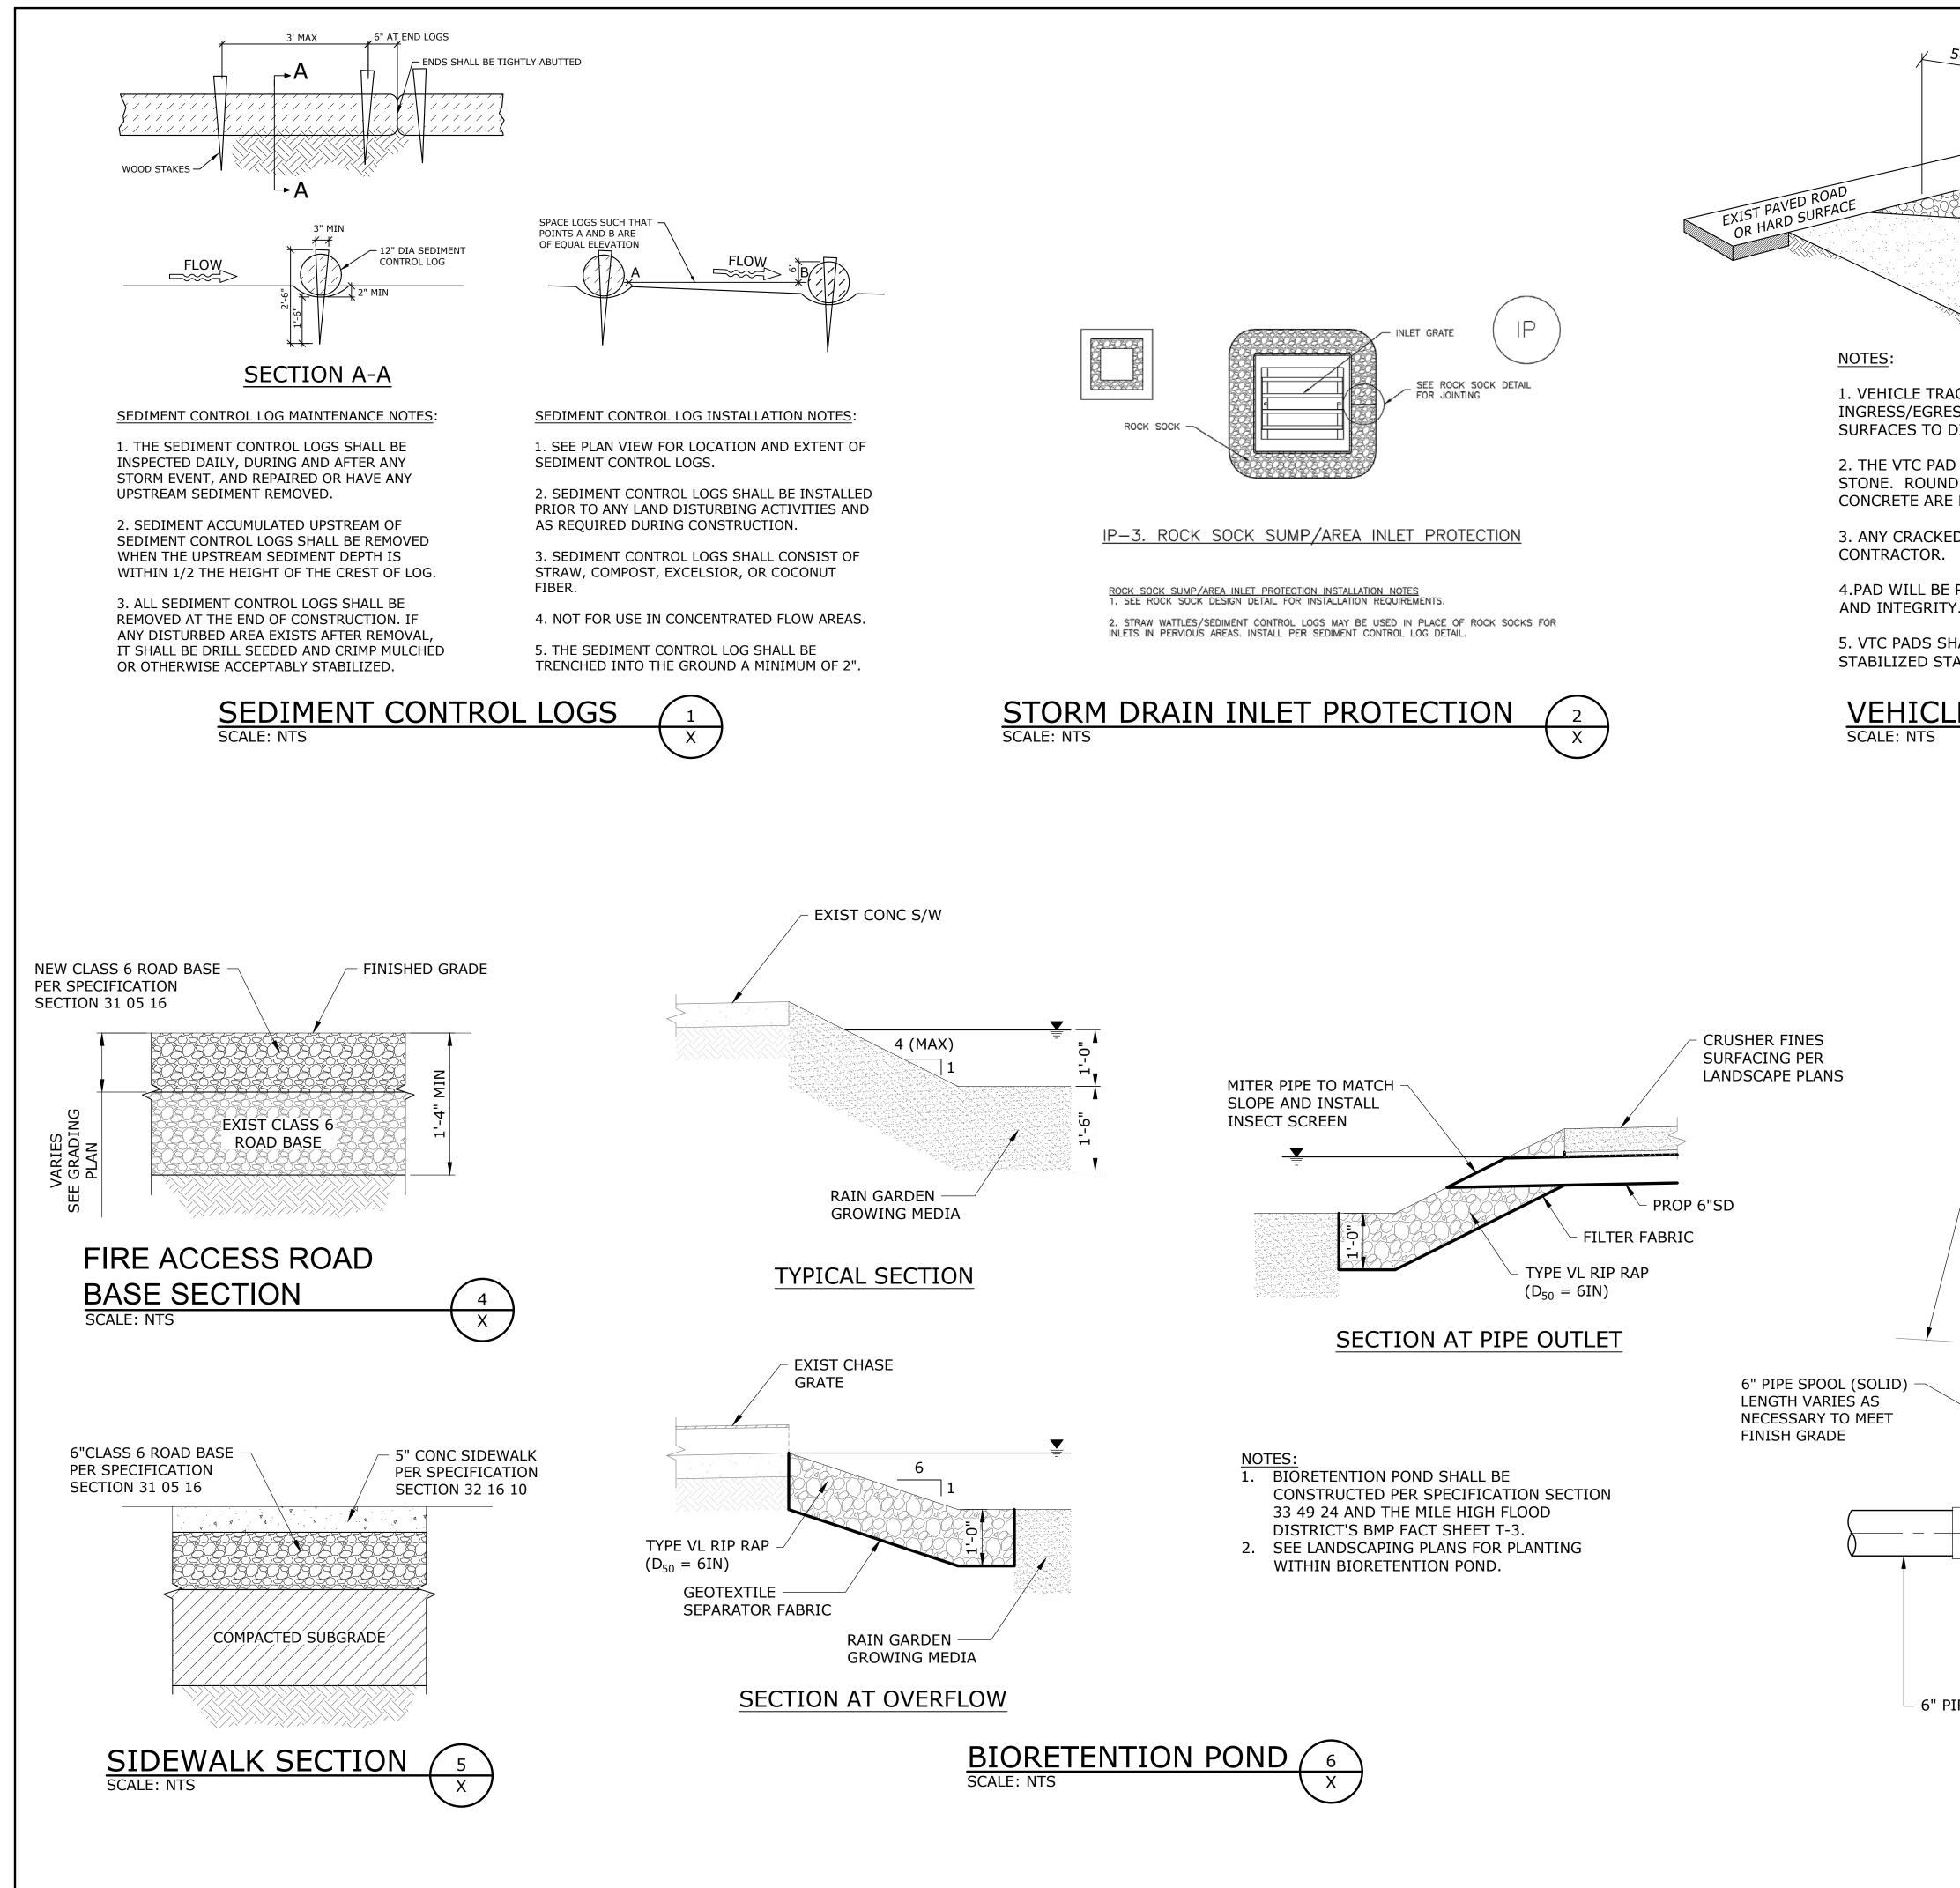
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CIVIL GRADING PLAN

CI03





50'-0" MIN LENGTH WIDTH VARIES (AS REQ'D)	ARCHITECTURE & INTERIORS
	409 east main street p o box 4175 frisco . colorado 80443 970 453 0444
 3" TO 6" ROCK AT 6" TO 12" DEPTH INSTALLED OVER LAYER OF NON-WOVEN GEOTEXTILE TRACKING CONTROL PADS SHALL BE INSTALLED AT ALL GRESS POINTS WHERE VEHICULAR ACCESS TRANSITIONS FROM PAVED O DISTURBED SURFACES. PAD SHALL CONSIST OF HARD, ANGULAR, DENSE, AND DURABLE UNDED STONE, BOULDERS, RECYCLED ASPHALT, AND RECYCLED ARE NOT ACCEPTABLE. CKED OR DAMAGED CURB AND/OR GUTTER SHALL BE REPLACED BY THE RR. BE REPAIRED AND REFRESHED AS NEEDED TO MAINTAIN FUNCTION RITY. SHALL BE INSTALLED AT ALL CONCRETE WASHOUT AREAS AND AT STAGING/STORAGE AREAS. CLE TRACKING CONTROL 	In the contract of the contrac
SLOPE FINISH GRADE TO DRAIN TOWARDS GRATE, KEEP GRATE 1/4" BELOW TOP OF SOIL 6" OR 4" ROUND NDS GRATE TO FIT WITH 6" OR 4" PIPE	Frisco bay marina site and landscape improvements 277 marina road frisco . colorado 277 marina road frisco . colorado PROJECT # 2161
G" X 4" REDUCE (FIRST RUN ONLY) (FIRST R	ISSUE: Review 5 may 2022 bid set 24 may 2022 bid clarification 30 june 2022 bid documents 19 sept 2022 IIIIIIIIIIIIIIIIIIIIIIIIIIIIIIIIII
AREA DRAIN SCALE HORZ: NTS 7	CIVIL SITE DETAILS
	C501

GENERAL NOTES

- 1. THESE PLANS SHALL NOT BE UTILIZED FOR CONSTRUCTION OR PERMITTING UNLESS
- STATED FOR SUCH USE IN THE TITLE BLOCK.
- 2. DRAWINGS ARE INTENDED TO BE PRINTED ON 24" X 36" PAPER. PRINTING THESE DRAWINGS AT A DIFFERENT SIZE WILL IMPACT THE SCALE. VERIFY THE GRAPHIC SCALE BEFORE REFERENCING ANY MEASUREMENTS ON THESE SHEETS. THE RECIPIENT OF THESE DRAWINGS SHALL BE RESPONSIBLE FOR ANY ERRORS RESULTING FROM INCORRECT PRINTING, COPYING, OR ANY OTHER CHANGES THAT ALTER THE SCALE OF THE DRAWINGS.
- 3. VERIFY ALL PLAN DIMENSIONS PRIOR TO START OF CONSTRUCTION. NOTIFY THE OWNER'S REPRESENTATIVE TO ADDRESS ANY QUESTIONS OR CLARIFY ANY DISCREPANCIES.
- WRITTEN DIMENSIONS TAKE PRECEDENCE OVER SCALED DIMENSIONS. 5. SUBMIT A CHANGE ORDER FOR APPROVAL FOR ANY CHANGES TO WORK SCOPE RESULTING FROM FIELD CONDITIONS OR DIRECTION BY OWNER'S REPRESENTATIVE WHICH REQUIRE ADDITIONAL COST TO THE OWNER PRIOR TO PERFORMANCE OF WORK.
- 6. THE CONTRACTOR SHALL PROVIDE A STAKED LAYOUT OF ALL SITE IMPROVEMENTS FOR INSPECTION BY THE OWNER'S REPRESENTATIVE AND MAKE MODIFICATIONS AS REQUIRED. ALL LAYOUT INFORMATION IS AVAILABLE IN DIGITAL FORMAT FOR USE BY THE CONTRACTOR.
- 7. IF A GEOTECHNICAL SOILS REPORT IS NOT AVAILABLE AT THE TIME OF CONSTRUCTION, NORRIS DESIGN RECOMMENDS A REPORT BE AUTHORIZED BY THE OWNER AND THAT ALL RECOMMENDATIONS OF THE REPORT ARE FOLLOWED DURING CONSTRUCTION. THE CONTRACTOR SHALL USE THESE CONTRACT DOCUMENTS AS A BASIS FOR THE BID. IF THE OWNER ELECTS TO PROVIDE A GEOTECHNICAL REPORT, THE CONTRACTOR SHALL REVIEW THE REPORT AND SUBMIT AN APPROPRIATE CHANGE ORDER TO THE OWNER'S REPRESENTATIVE IF ADDITIONAL COSTS ARE REQUESTED.
- 8. CONTRACTOR SHALL CONFIRM THAT SITE CONDITIONS ARE SIMILAR TO THE PLANS, WITHIN TOLERANCES STATED IN THE CONTRACT DOCUMENTS, AND SATISFACTORY TO THE CONTRACTOR PRIOR TO START OF WORK. SHOULD SITE CONDITIONS BE DIFFERENT THAN REPRESENTED ON THE PLANS OR UNSATISFACTORY TO THE CONTRACTOR, THE CONTRACTOR SHALL CONTACT THE OWNER'S REPRESENTATIVE FOR CLARIFICATION AND FURTHER DIRECTION.
- CONTRACTOR IS RESPONSIBLE TO PAY FOR, AND OBTAIN, ANY REQUIRED APPLICATIONS, 9. PERMITTING, LICENSES, INSPECTIONS AND METERS ASSOCIATED WITH WORK.
- 10. THE CONTRACTOR SHALL BE RESPONSIBLE FOR ANY FINES OR PENALTIES ASSESSED TO THE OWNER RELATING TO ANY VIOLATIONS OR NON-CONFORMANCE WITH THE PLANS, SPECIFICATIONS, CONTRACT DOCUMENTS, JURISDICTIONAL CODES, AND REGULATORY AGENCIES.
- 11. THE CONTRACTOR SHALL BE RESPONSIBLE FOR COORDINATION OF ALL UTILITY LOCATES PRIOR TO ANY EXCAVATION. REFER TO ENGINEERING UTILITY PLANS FOR ALL PROPOSED UTILITY LOCATIONS AND DETAILS. NOTIFY OWNER'S REPRESENTATIVE IF EXISTING OR PROPOSED UTILITIES INTERFERE WITH THE ABILITY TO PERFORM WORK
- 12. UNLESS IDENTIFIED ON THE PLANS FOR DEMOLITION OR REMOVAL, THE CONTRACTOR IS RESPONSIBLE FOR THE COST TO REPAIR UTILITIES, ADJACENT OR EXISTING LANDSCAPE ADJACENT OR EXISTING PAVING, OR ANY PUBLIC AND PRIVATE PROPERTY THAT IS DAMAGED BY THE CONTRACTOR OR THEIR SUBCONTRACTOR'S OPERATIONS DURING INSTALLATION, ESTABLISHMENT OR DURING THE SPECIFIED MAINTENANCE PERIOD. ALL DAMAGES SHALL BE REPAIRED TO PRE-CONSTRUCTION CONDITIONS AS DETERMINED BY THE OWNER'S REPRESENTATIVE. CONTRACTOR SHALL BE RESPONSIBLE FOR LOGGING ANY DAMAGES PRIOR TO START OF CONSTRUCTION AND DURING THE CONTRACT PERIOD.
- 13. ALL WORK SHALL BE CONFINED TO THE AREA WITHIN THE CONSTRUCTION LIMITS AS SHOWN ON THE PLANS. ANY AREAS OR IMPROVEMENTS DISTURBED OUTSIDE THESE LIMITS SHALL BE RETURNED TO THEIR ORIGINAL CONDITION AT THE CONTRACTOR'S EXPENSE. IN THE EVENT THE CONTRACTOR REQUIRES A MODIFICATION TO THE CONSTRUCTION LIMITS, WRITTEN PERMISSION MUST BE OBTAINED FROM THE OWNER'S REPRESENTATIVE PRIOR TO ANY DISTURBANCE OUTSIDE OF THE LIMITS OF WORK.
- 14. THE CONTRACTOR SHALL BE RESPONSIBLE FOR THE REPAIR OF ANY OF THEIR TRENCHES OR EXCAVATIONS THAT SETTLE.
- 15. THE CONTRACTOR SHALL BE RESPONSIBLE TO PREPARE AND SUBMIT A TRAFFIC CONTROL PLAN TO THE APPROPRIATE JURISDICTIONAL AGENCIES AND THE OWNER'S REPRESENTATIVE IF THEIR WORK AND OPERATIONS AFFECT OR IMPACT THE PUBLIC RIGHTS-OF-WAY. OBTAIN APPROVAL PRIOR TO ANY WORK WHICH AFFECTS OR IMPACTS THE PUBLIC RIGHTS-OF-WAY. THE CONTRACTOR SHALL BE RESPONSIBLE FOR ANY FINES OR PENALTIES ASSESSED TO THE OWNER RELATING TO THIS REQUIREMENT DURING THE CONTRACT PERIOD.
- 16. SIGHT TRIANGLES AND SIGHT LINES SHALL REMAIN UNOBSTRUCTED BY EQUIPMENT, CONSTRUCTION MATERIALS, PLANT MATERIAL OR ANY OTHER VISUAL OBSTACLE DURING THE CONTRACT PERIOD AND AT MATURITY OF PLANTS PER LOCAL JURISDICTIONAL REQUIREMENTS. NO PLANT MATERIAL OTHER THAN GROUND COVER IS ALLOWED TO BE PLANTED ADJACENT TO FIRE HYDRANTS AS STIPULATED BY JURISDICTIONAL REQUIREMENTS.

- 17. COORDINATE SITE ACCESS, STAGING, STORAGE AND CLEAN OUT AREAS WITH OWNER'S REPRESENTATIVE.
- 18. CONTRACTOR IS RESPONSIBLE FOR PROVIDING TEMPORARY SAFETY FENCING AND BARRIERS AROUND ALL IMPROVEMENTS SUCH AS WALLS, PLAY STRUCTURES, EXCAVATIONS, ETC. ASSOCIATED WITH THEIR WORK UNTIL SUCH FACILITIES ARE COMPLETELY INSTALLED PER THE PLANS, SPECIFICATIONS AND MANUFACTURER'S RECOMMENDATIONS.
- 19. CONTRACTOR SHALL BE RESPONSIBLE FOR PROTECTION OF THEIR MATERIAL STOCK PILES AND WORK FROM VANDALISM. EROSION OR UNINTENDED DISTURBANCE DURING THE CONSTRUCTION PERIOD AND UNTIL FINAL ACCEPTANCE IS ISSUED.
- 20. THE CONTRACTOR SHALL KNOW. UNDERSTAND AND ABIDE BY ANY STORM WATER POLLUTION PREVENTION PLAN (SWPPP) ASSOCIATED WITH THE SITE. IF A STORM WATER POLLUTION PREVENTION PLAN IS NOT PROVIDED BY THE OWNER'S REPRESENTATIVE, REQUEST A COPY BEFORE PERFORMANCE OF ANY SITE WORK.
- MAINTAIN ANY STORM WATER MANAGEMENT FACILITIES THAT EXIST ON SITE FOR FULL 21. FUNCTIONALITY. THE CONTRACTOR SHALL INSTALL AND MAINTAIN ANY NEW STORM WATER MANAGEMENT FACILITIES THAT ARE IDENTIFIED IN THE SCOPE OF WORK TO FULL FUNCTIONALITY. THE CONTRACTOR SHALL BE RESPONSIBLE FOR ANY FINES OR PENALTIES ASSESSED TO THE OWNER FOR FAILURE TO MAINTAIN STORM WATER MANAGEMENT FACILITIES DURING THE CONTRACT PERIOD.
- 22. THE CONTRACTOR SHALL PREVENT SEDIMENT, DEBRIS AND ALL OTHER POLLUTANTS FROM EXITING THE SITE OR ENTERING THE STORM SEWER SYSTEM DURING ALL DEMOLITION OR CONSTRUCTION OPERATIONS THAT ARE PART OF THIS PROJECT. THE CONTRACTOR SHALL BE RESPONSIBLE FOR ANY FINES OR PENALTIES ASSESSED TO THE OWNER RELATING TO THESE REQUIREMENTS DURING THEIR CONTRACTED COURSE OF WORK.
- 23. THE CONTRACTOR SHALL BE RESPONSIBLE TO PREVENT ANY IMPACTS TO ADJACENT WATERWAYS, WETLANDS, OR OTHER ENVIRONMENTALLY SENSITIVE AREAS RESULTING FROM WORK DONE AS PART OF THIS PROJECT. THE CONTRACTOR SHALL BE RESPONSIBLE FOR ANY FINES OR PENALTIES ASSESSED TO THE OWNER RELATING TO THESE STANDARDS DURING THEIR CONTRACTED COURSE OF WORK
- 24. THE CONTRACTOR AND/OR THEIR AUTHORIZED AGENTS SHALL ENSURE THAT ALL LOADS OF CONSTRUCTION MATERIAL IMPORTED TO OR EXPORTED FROM THE PROJECT SITE SHALL BE PROPERLY COVERED TO PREVENT LOSS OF MATERIAL DURING TRANSPORT. TRANSPORTATION METHODS ON PUBLIC RIGHT-OF WAYS SHALL CONFORM TO JURISDICTIONAL REQUIREMENTS. THE CONTRACTOR SHALL BE RESPONSIBLE FOR ANY FINES OR PENALTIES ASSESSED TO THE OWNER RELATING TO THESE REQUIREMENTS. 25. THE CLEANING OF EQUIPMENT IS PROHIBITED AT THE JOB SITE UNLESS AUTHORIZED BY THE OWNER'S REPRESENTATIVE IN A DESIGNATED AREA. THE DISCHARGE OF WATER, WASTE CONCRETE, POLLUTANTS, OR OTHER MATERIALS SHALL ONLY OCCUR IN AREAS DESIGNED FOR SUCH USE AND APPROVED BY THE OWNER'S REPRESENTATIVE 26. THE CLEANING OF CONCRETE EQUIPMENT IS PROHIBITED AT THE JOB SITE EXCEPT IN DESIGNATED CONCRETE WASHOUT AREAS. THE DISCHARGE OF WATER CONTAINING
- WASTE CONCRETE IN THE STORM SEWER IS PROHIBITED.
- 27. OPEN SPACE SWALES: IF SWALES ARE EXISTING ON SITE AND ARE NOT INTENDED TO BE MODIFIED AS PART OF THE PLANS, THE CONTRACTOR SHALL BE RESPONSIBLE TO MAINTAIN THE CONVEYANCE OF WATER WITHIN THE SWALES DURING THE CONTRACT PERIOD. THE CONTRACTOR SHALL BE RESPONSIBLE FOR ANY DIVERSION OR PUMPING OF WATER IF REQUIRED TO COMPLETE WORK. ANY SWALES DISTURBED BY THE CONTRACTOR SHALL BE REPAIRED/RESTORED TO THEIR ORIGINAL CONDITION. IF THE SWALE NEEDS TO BE DISTURBED OR MODIFIED FOR ANY REASON, THE CONTRACTOR SHALL NOTIFY THE OWNER'S REPRESENTATIVE FOR APPROVAL PRIOR TO DISTURBANCE
- DETENTION AND WATER QUALITY PONDS: IF DETENTION PONDS AND WATER QUALITY 28. PONDS ARE EXISTING ON SITE AND ARE NOT INTENDED TO BE MODIFIED AS PART OF THE PLANS, THE CONTRACTOR SHALL MINIMIZE DISTURBANCE TO THE PONDS, DRAINAGE STRUCTURES AND SPILLWAYS DURING CONSTRUCTION. ALL PONDS, DRAINAGE STRUCTURES AND SPILLWAYS SHALL BE MAINTAINED IN OPERABLE CONDITIONS AT ALL TIMES. ANY POND OR SPILLWAY AREAS DISTURBED BY THE CONTRACTOR SHALL BE REPAIRED/RESTORED TO THEIR ORIGINAL CONDITION. IF THE POND NEEDS TO BE DISTURBED OR MODIFIED FOR ANY REASON. THE CONTRACTOR SHALL NOTIFY THE OWNER'S REPRESENTATIVE FOR APPROVAL PRIOR TO DISTURBANCE. 29. LOCAL. STATE AND FEDERAL JURISDICTIONAL REQUIREMENTS. RESTRICTIONS OR
- PROCEDURES SHALL SUPERSEDE THESE PLANS. NOTES AND SPECIFICATIONS WHEN MORE STRINGENT. NOTIFY THE OWNER'S REPRESENTATIVE IF CONFLICTS OCCUR.

LANDSCAPE NOTES

- THE CONTRACTOR SHALL FOLLOW THE LANDSCAPE PLANS AND SPECIFICATIONS AS CLOSELY AS POSSIBLE. ANY SUBSTITUTION OR ALTERATION SHALL NOT BE ALLOWED WITHOUT APPROVAL OF THE OWNER'S REPRESENTATIVE. OVERALL PLANT QUANTITY AND QUALITY SHALL BE CONSISTENT WITH THE PLANS.
- 2. THE CONTRACTOR IS RESPONSIBLE FOR VERIFYING ALL PLANT QUANTITIES. GRAPHIC QUANTITIES TAKES PRECEDENCE OVER WRITTEN QUANTITIES.
- THE OWNER'S REPRESENTATIVE RESERVES THE RIGHT TO INSPECT AND TAG ALL PLANT MATERIAL PRIOR TO SHIPPING TO THE SITE. IN ALL CASES, THE OWNER'S REPRESENTATIVE MAY REJECT PLANT MATERIAL AT THE SITE IF MATERIAL IS DAMAGED, DISEASED, OR DECLINING IN HEALTH AT THE TIME OF ONSITE INSPECTIONS OR IF THE PLANT MATERIAL DOES NOT MEET THE MINIMUM SPECIFIED STANDARD IDENTIFIED ON THE PLANS AND IN THE SPECIFICATIONS. THE CONTRACTOR SHALL COORDINATE WITH THE OWNER'S REPRESENTATIVE FOR INSPECTION AND APPROVAL OF ALL MATERIALS AND PRODUCTS PRIOR TO INSTALLATION.
- 4. THE OWNER'S REPRESENTATIVE MAY ELECT TO UPSIZE PLANT MATERIAL AT THEIR DISCRETION BASED ON SELECTION, AVAILABILITY, OR TO ENHANCE SPECIFIC AREAS OF THE PROJECT. THE CONTRACTOR SHALL VERIFY PLANT MATERIAL SIZES WITH OWNER'S REPRESENTATIVE PRIOR TO PURCHASING, SHIPPING OR STOCKING OF PLANT MATERIALS. SUBMIT CHANGE ORDER REQUEST TO OWNER'S REPRESENTATIVE FOR APPROVAL IF ADDITIONAL COST IS REQUESTED BY THE CONTRACTOR PRIOR TO INSTALLATION. RE-STOCKING CHARGES WILL NOT BE APPROVED IF THE CONTRACTOR FAILS TO SUBMIT A REQUEST FOR MATERIAL CHANGES.
- 5. THE CONTRACTOR SHALL WARRANTY ALL CONTRACTED WORK AND MATERIALS FOR A PERIOD OF YEAR AFTER SUBSTANTIAL COMPLETION HAS BEEN ISSUED BY THE OWNER'S REPRESENTATIVE FOR THE ENTIRE PROJECT UNLESS OTHERWISE SPECIFIED IN THE CONTRACT DOCUMENTS OR SPECIFICATIONS.
- REFER TO IRRIGATION PLANS FOR LIMITS AND TYPES OF IRRIGATION DESIGNED FOR THE LANDSCAPE. IN NO CASE SHALL IRRIGATION BE EMITTED WITHIN THE MINIMUM DISTANCE FROM BUILDING OR WALL FOUNDATIONS AS STIPULATED IN THE GEOTECHNICAL REPORT. ALL IRRIGATION DISTRIBUTION LINES, HEADS AND EMITTERS SHALL BE KEPT OUTSIDE THE MINIMUM DISTANCE AWAY FROM ALL BUILDING AND WALL FOUNDATIONS AS STIPULATED IN THE GEOTECHNICAL REPORT.
- 7. LANDSCAPE MATERIAL LOCATIONS SHALL HAVE PRECEDENCE OVER IRRIGATION MAINLINE AND LATERAL LOCATIONS. COORDINATE INSTALLATION OF IRRIGATION EQUIPMENT SO THAT IT DOES NOT INTERFERE WITH THE PLANTING OF TREES OR OTHER LANDSCAPE MATERIAL.
- 8. THE LANDSCAPE CONTRACTOR SHALL BE RESPONSIBLE FOR ENSURING POSITIVE DRAINAGE EXISTS IN ALL LANDSCAPE AREAS. SURFACE DRAINAGE ON LANDSCAPE AREAS SHALL NOT FLOW TOWARD STRUCTURES AND FOUNDATIONS. MAINTAIN SLOPE AWAY FROM FOUNDATIONS PER THE GEOTECHNICAL REPORT RECOMMENDATIONS. ALL LANDSCAPE AREAS BETWEEN WALKS AND CURBS SHALL DRAIN FREELY TO THE CURB UNLESS OTHERWISE IDENTIFIED ON THE GRADING PLAN. IN NO CASE SHALL THE GRADE, TURF THATCH, OR OTHER LANDSCAPE MATERIALS DAM WATER AGAINST WALKS. MINIMUM SLOPES ON LANDSCAPE AREAS SHALL BE 2%; MAXIMUM SLOPE SHALL BE 25% UNLESS SPECIFICALLY IDENTIFIED ON THE PLANS OR APPROVED BY THE OWNER'S REPRESENTATIVE.
- 9. PRIOR TO INSTALLATION OF PLANT MATERIALS, AREAS THAT HAVE BEEN COMPACTED OR DISTURBED BY CONSTRUCTION ACTIVITY SHALL BE THOROUGHLY LOOSENED TO A DEPTH OF 8" - 12" AND AMENDED PER SPECIFICATIONS.
- 10. ALL LANDSCAPED AREAS ARE TO RECEIVE ORGANIC SOIL PREPARATION AS NOTED IN THE TECHNICAL SPECIFICATIONS.
- TREES SHALL NOT BE LOCATED IN DRAINAGE SWALES, DRAINAGE AREAS, OR UTILITY EASEMENTS. CONTACT OWNER'S REPRESENTATIVE FOR RELOCATION OF PLANTS IN QUESTIONABLE AREAS PRIOR TO INSTALLATION.

LAYOUT NOTES

- WRITTEN DIMENSIONS WILL TAKE PRECEDENCE OVER SCALED DIMENSIONS. 2. SHOULD SITE CONDITIONS BE DIFFERENT THAN WHAT IS INDICATED ON THE DRAWINGS
- CONTACT THE LANDSCAPE ARCHITECT IMMEDIATELY FOR CLARIFICATION. CURVED WALKS AND CURB EDGES ARE INTENDED TO BE CONSTRUCTED WITH SMOOTH - 3.
- FLOWING CURVES. ANYTHING OTHER THAN SMOOTH FLOWING CURVES WILL BE REJECTED 4. THE CONTRACTOR SHALL OBTAIN, AT HIS EXPENSE, ALL PERMITS WHICH ARE NECESSARY TO PERFORM THE PROPOSED WORK.
- 5. THE CONTRACTOR SHALL PROVIDE A STAKED LAYOUT OF ALL SITE IMPROVEMENTS FOR INSPECTION BY THE OWNER'S REPRESENTATIVE AND MAKE MODIFICATIONS AS REQUIRED AT NO ADDITIONAL COST TO THE OWNER.
- THE CONTRACTOR SHALL INSTALL SLEEVING FOR IRRIGATION IMPROVEMENTS PRIOR TO INSTALLING CONCRETE FLATWORK. REFER TO IRRIGATION PLANS.
- 7. LAYOUT WALKS, SCORE JOINTS AND PAVING PATTERNS AS CLOSELY AS POSSIBLE TO PLANS, DETAILS, AND SPECIFICATIONS. DO NOT DEVIATE FROM PLANS UNLESS SPECIFIC APPROVAL IS OBTAINED FROM THE OWNER'S REPRESENTATIVE.
- 8. ALL WORK SHALL BE CONFINED TO THE AREA WITHIN THE CONSTRUCTION LIMITS AS SHOWN ON THE PLANS. ANY AREAS OR IMPROVEMENTS DISTURBED OUTSIDE THESE LIMITS SHALL BE RETURNED TO THEIR ORIGINAL CONDITION AT THE CONTRACTOR'S EXPENSE. IN THE EVENT THE CONTRACTOR REQUIRES A MODIFICATION TO THE CONSTRUCTION LIMITS, WRITTEN PERMISSION MUST BE OBTAINED FROM THE LANDSCAPE ARCHITECT PRIOR TO ANY DISTURBANCE OUTSIDE OF THE LIMITS OF WORK. SEE TECHNICAL SPECIFICATIONS.
- CONTRACTOR IS RESPONSIBLE FOR SUPERVISING ALL SAFETY SURFACING AND PAVEMENT DURING THE CURING PROCESS.

- REPRESENTATIVE. AREAS.

- THE PLANS.

- L-001 L-002 L-003 L-101 L-401 L-402 L-501 LS-101 LS-501
- LS-502

THE CENTER OF EVERGREEN TREES SHALL NOT BE PLACED CLOSER THAN 8' AND THE CENTER OF ORNAMENTAL TREES CLOSER THAN 6' FROM A SIDEWALK, STREET OR DRIVE LANE. EVERGREEN TREES SHALL NOT BE LOCATED ANY CLOSER THAN 15' FROM IRRIGATION ROTOR HEADS. NOTIFY OWNER'S REPRESENTATIVE IF TREE LOCATIONS CONFLICT WITH THESE STANDARDS FOR FURTHER DIRECTION.

13. ALL EVERGREEN TREES SHALL BE FULLY BRANCHED TO THE GROUND AND SHALL NOT EXHIBIT SIGNS OF ACCELERATED GROWTH AS DETERMINED BY THE OWNER'S

14. ALL TREES ARE TO BE STAKED AND GUYED PER DETAILS FOR A PERIOD OF 3 YEARS. THE CONTRACTOR SHALL BE RESPONSIBLE FOR REMOVING STAKES AT THE END OF 3 YEARS FROM ACCEPTANCE OF LANDSCAPE INSTALLATION BY THE OWNER'S REPRESENTATIVE. OBTAIN APPROVAL BY OWNER'S REPRESENTATIVE PRIOR TO REMOVAL

15. ALL TREES INSTALLED ABOVE RETAINING WALLS UTILIZING GEO-GRID MUST BE HAND DUG TO PROTECT GEO-GRID. IF GEO-GRID MUST BE CUT TO INSTALL TREES, APPROVAL MUST BE GIVEN BY OWNER'S REPRESENTATIVE PRIOR TO DOING WORK

 SHRUB, GROUNDCOVER AND PERENNIAL BEDS ARE TO BE CONTAINED BY PLASTIC EDGER EDGER IS NOT REQUIRED WHEN ADJACENT TO CURBS, WALLS, WALKS OR SOLID FENCES WITHIN 3" OF PRE-MULCHED FINAL GRADE. EDGER SHALL NOT BE REQUIRED TO SEPARATE MULCH TYPES UNLESS SPECIFIED ON THE PLANS.

17. ALL SHRUB BEDS ARE TO BE MULCHED LANDSCAPE MULCH OVER GEOTEXTILE WEED CONTROL FABRIC AS SPECIFIED IN THE TECHNICAL SPECIFICATIONS OR MATERIALS SCHEDULE. ALL GROUND COVER AND PERENNIAL FLOWER BEDS SHALL BE MULCHED WITH LANDSCAPE MULCH AS SPECIFIED IN THE TECHNICAL SPECIFICATIONS OR MATERIALS SCHEDULE. NO WEED CONTROL FABRIC IS REQUIRED IN GROUNDCOVER OR PERENNIAL

18. AT SEED AREA BOUNDARIES ADJACENT TO EXISTING NATIVE AREAS, OVERLAP ABUTTING NATIVE AREAS BY THE FULL WIDTH OF THE SEEDER.

19. EXISTING TURF AREAS THAT ARE DISTURBED DURING CONSTRUCTION, ESTABLISHMENT AND THE MAINTENANCE PERIOD SHALL BE RESTORED WITH NEW SOD TO MATCH EXISTING TURF SPECIES. DISTURBED NATIVE AREAS WHICH ARE TO REMAIN SHALL BE OVER SEEDED AND RESTORED WITH SPECIFIED SEED MIX.

20. CONTRACTOR SHALL OVER SEED ALL MAINTENANCE OR SERVICE ACCESS BENCHES AND ROADS WITH SPECIFIED SEED MIX UNLESS OTHERWISE NOTED ON THE PLANS.

21. ALL SEEDED SLOPES EXCEEDING 25% IN GRADE (4:1) SHALL RECEIVE EROSION CONTROL BLANKETS. PRIOR TO INSTALLATION, NOTIFY OWNER'S REPRESENTATIVE FOR APPROVAL OF LOCATION AND ANY ADDITIONAL COST IF A CHANGE ORDER IS NECESSARY.

22. WHEN COMPLETE, ALL GRADES SHALL BE WITHIN +/- 1/8" OF FINISHED GRADES AS SHOWN ON

23. SOFT SURFACE TRAILS NEXT TO MANICURED TURF OR SHRUB BEDS SHALL BE CONTAINED WITH EDGER SPECIFIED IN PLANS OR APPROVED EQUAL

24. PRIOR TO THE PLACEMENT OF MULCH AND WEED FABRIC, A GRANULAR, PRE-EMERGENT WEED CONTROL AGENT SHALL BE ADDED TO ALL PLANTING BEDS IN ACCORDANCE WITH THE MANUFACTURER'S INSTRUCTION, EXCEPT AROUND ORNAMENTAL GRASSES 25. THE CONTRACTOR IS EXPECTED TO KNOW AND UNDERSTAND THE TOWN AND COUNTY SPECIFICATIONS FOR LANDSCAPE AND IRRIGATION. IN CASES OF DISCREPANCIES THE

HIGHER OF THE TWO STANDARDS SHALL HAVE PRECEDENCE 26. THE DEVELOPER, HIS SUCCESSORS AND ASSIGNS SHALL BE RESPONSIBLE FOR THE INSTALLATION, MAINTENANCE AND REPLACEMENT OF ALL IMPROVEMENTS SHOWN OR INDICATED ON THE APPROVED LANDSCAPE PLAN ON FILE IN THE PLANNING DEPARTMENT

SHEET LIST

LANDSCAPE NOTES LANDSCAPE SCHEDULES MATERIAL AND AMENITY SCHEDULES LANDSCAPE PLAN PLANTING ENLARGEMENT PLANTING ENLARGEMENT LANDSCAPE DETAILS HARDSCAPE PLAN HARDSCAPE DETAILS HARDSCAPE DETAILS

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970.668.5276

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> SHEET TITLE: LANDSCAPE NOTES



PLANT SCHEDULE											
DECIDUOUS TREES	CODE	BOTANICAL NAME	COMMON NAME	ROOT	SIZE	NOTES	PERENNIALS	<u>CODE</u>	BOTANICAL NAME	COMMON NAME	ROOT
<i>.</i> .	PO AC	POPULUS TREMULOIDES	QUAKING ASPEN	B & B	1.5"CAL	MULTI-STE		AC PA	ACHILLEA MILLEFOLIUM 'PAPRIKA'	PAPRIKA COMMON YARROW	CONT.
	PO TR	POPULUS TREMULOIDES	QUAKING ASPEN	B & B	2"CAL		×××	AC MO	ACHILLEA X `MOONSHINE`	MOONSHINE YARROW	CONT.
DECIDUOUS SHRUBS	CODE	BOTANICAL NAME	COMMON NAME	<u>ROOT</u>	SIZE	NOTES		AL AL	ALCHEMILLA ALPINA	ALPINE LADY`S MANTLE	CONT.
	AM SO	AMELANCHIER ALNIFOLIA `STANDING OVATION` TM	STANDING OVATION SERVICEBERRY	CONT.	#5		(+)	AQ CA	AQUILEGIA CAERULEA	ROCKY MOUNTAIN COLUMBINE	CONT.
•	CH AL	CHRYSOTHAMNUS NAUSEOSUS ALBICAULIS	TALL BLUE RABBITBRUSH	CONT.	#5			AR UV	ARCTOSTAPHYLOS UVA-URSI	KINNIKINNICK	CONT.
\bigotimes	CO AF	CORNUS SERICEA `ARCTIC FIRE`	ARCTIC FIRE DOGWOOD	CONT.	#5			AS AL	ASTER ALPINUS	ALPINE ASTER	CONT.
	JA AM	JAMESIA AMERICANA	WAXFLOWER	CONT.	#5			CA OL	CAMPANULA ROTUNDIFOLIA 'OLYMPICA'	OLYMPICA HAREBELL	CONT.
Contraction of the second s	MA RE	MAHONIA REPENS	CREEPING MAHONIA	CONT.	#1			CE TO	CERASTIUM TOMENTOSUM	SNOW IN SUMMER	CONT.
	PH MO	PHYSOCARPUS MONOGYNUS	MOUNTAIN NINEBARK	CONT.	#1		E C C C C C C C C C C C C C C C C C C C	DE FO	DELPHINIUM X `MAGIC FOUNTAINS`	MAGIC FOUNTAIN DELPHINIUM	CONT.
	PO MW	POTENTILLA FRUTICOSA `MCKAY`S WHITE`	MCKAY'S WHITE BUSH CINQUEFOIL	CONT.	#1		ور بر کنیک کنیک	DE BL	DELPHINIUM X 'BLACK KNIGHT'	BLACK KNIGHT DELPHINUM	CONT.
\odot	PO PB	POTENTILLA FRUTICOSA `PINK BEAUTY`	PINK BEAUTY POTENTILLA	CONT	#1		\bigcirc	EC PU	ECHINACEA PURPUREA	PURPLE CONEFLOWER	CONT.
\bigotimes	PO KA	POTENTILLA FRUTICOSA 'KATHERINE DYKES'	KATHERINE DYKES BUSH CINQUEFOIL	CONT.	#1		Ê	ES CA	ESCHSCHOLZIA CALIFORNICA	CALIFORNIA POPPY	CONT.
	RO WO	ROSA WOODSII	MOUNTAIN ROSE	CONT.	#5			GA AR	GAILLARDIA ARISTATA	NATIVE BLANKET FLOWER	CONT.
	SA EX	SALIX EXIGUA	COYOTE WILLOW	CONT.	#5		\bigotimes	LE SC	LEUCANTHEMUM X SUPERBUM `SNOWCAP`	SNOWCAP SHASTA DAISY	CONT.
	SA PU	SALIX PURPUREA `NANA`	DWARF ARCTIC WILLOW	CONT	#5		543	LU PO	LUPINUS X 'POPSICLE BLUE'	POPSICLE BLUE LUPINE	CONT.
ORNAMENTAL GRASSES	CODE	BOTANICAL NAME	COMMON NAME	ROOT	SIZE	NOTES	<	ME IE	MERTENSIA LANCEOLATA	PRAIRIE BLUEBELLS	CONT.
NUUVUU	AN PP	ANDROPOGON GERARDII PAWNEE	PAWNEE BIG BLUESTEM	CONT.	#1			PE ST	PENSTEMON STRICTUS	ROCKY MOUNTAIN PENSTEMON	CONT.
Short	DE TU	DESCHAMPSIA CESPITOSA	TUFTED HAIR GRASS	CONT.	#1		×	PH BI	PHLOX BIFIDA	SNOWMASS PHLOX	CONT.
	FE EB	FESTUCA GLAUCA `ELIJAH BLUE`	BLUE FESCUE	CONT	#1		•	RU FU	RUDBECKIA FULGIDA `GOLDSTRUM`	BLACK-EYED SUSAN	CONT.
							Exercise of the second se	SE AJ	SEDUM X `AUTUMN JOY`	AUTUMN JOY SEDUM	CONT.

TURF GRASS

COMMON NAME BLACK BEAUTY FESCUE (OR APPROVED EQUAL) SUPPLIER: GRAFF'S TURF FORT MORGAN, CO

https://graffsturf.com/turfgrass/black-beauty-fescue/

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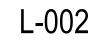


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> SHEET TITLE: LANDSCAPE SCHEDULES



SIZE	NOTES
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ITEM	DESCRIPTION	MANUFACTURER	CONTACT	PRODUCT NAME	PRODUCT NUMBER	COLOR/FINISH	NOTES
<u>S-101</u>	TRASH AND RECYCLING RECEPTACLE	SITE PIECES	CONTACT: 800.484.0797 www.sitepieces.com	MONOLIINE LITTER BIN	ML-LGLITTER-DL 27" X 14" X 42"H (36GAL)	BLACK POWDER COAT	SURFACE MOUNT ON CONCRETE PER MANUFACTURER SPECIFICATIONS. REFER TO DETAIL 1/LS-501 FOR SURFACE MOUNT IN CRUSHER FINES. REFER TO PLANS FOR LOCATION AND QUANTITY.
<u>S-102</u>	BIKE RACK	SITE PIECES	CONTACT: 800.484.0797 www.sitepieces.com	MONOLINE STANDARD BIKE ROAD	ML-STAND-19	BLACK POWDER COAT	SURFACE MOUNT ON CONCRETE PER MANUFACTURER SPECIFICATIONS. REFER TO DETAIL 1/LS-501 FOR SURFACE MOUNT IN CRUSHER FINES. REFER TO PLANS FOR LOCATION AND QUANTITY.
<u>S-103</u>	CURVED BENCH	DuMOR (OR APPROVED EQUAL)	CONTACT: 800.598.4018 sales@dumor.com	520 COLLECTION	R521-120-01 120" RADIUS, 96" BENCH	BLACK POWDER COAT, ANTIQUE MAHOGANY TEXTURED WOOD GRAIN RECYCLED PLASTIC	SURFACE MOUNT ON CONCRETE PER MANUFACTURER SPECIFICATIONS. REFER TO DETAIL 1/LS-501 FOR SURFACE MOUNT IN CRUSHER FINES. REFER TO PLANS FOR LOCATION AND QUANTITY.
S-104	STRAIGHT BENCH	DuMOR (OR APPROVED EQUAL)	CONTACT: 800.598.4018 sales@dumor.com	520 COLLECTION	521-60 BACKLESS 72" BENCH	BLACK POWDER COAT, ANTIQUE MAHOGANY TEXTURED WOOD GRAIN RECYCLED PLASTIC	SURFACE MOUNT ON CONCRETE PER MANUFACTURER SPECIFICATIONS. REFER TO DETAIL 1/LS-501 FOR SURFACE MOUNT IN CRUSHER FINES. REFER TO PLANS FOR LOCATION AND QUANTITY.
S-105	PICNIC TABLES	DuMOR (OR APPROVED EQUAL)	CONTACT: 800.598.4018 sales@dumor.com	520 COLLECTION	525-60TXM\S-5 FREESTANDING TABLE SET & ADA ACCESSIBLE 525-663TXM\S-5 FREESTANDING	BLACK POWDER COAT, ANTIQUE MAHOGANY TEXTURED WOOD GRAIN RECYCLED PLASTIC	LOCATE PER PLANS, ONE TABLE TO BE ADA ACCESSIBLE PER PLANS
S-106	PEDESTRIAN BOLLARD	FIRST LIGHT TECHNOLOGIES LTD (OR APPROVED EQUAL)	CONTACT: 844.279.8754 www.firstlighttechnologies.com	PLB SOLAR POWERED BOLLARD	6" x 35" BOLLARD, WARM WHITE 3000K LED, PLB TYPE 3 LIGHT DISTRIBUTION, LIGHT PROFILE 3	BLACK POWDER COAT	MOUNT PER MANUFACTURER'S SPECIFICATIONS
S-107	SIGNAGE POST	BY OWNER	CONTACT:	CUSTOM STREET LIGHT TO MATCH EXISTING TOWN STANDARD	CUSTOM	WOOD STAINED TO MATCH EXISTING STREET LIGHTS	TO BE INSTALLED BY OWNER. CONTRACTOR TO SUPPLY CONCRETE FOOTER PER DETAIL 1 / LS-502.
S-108	DOG BAGS	MUTT MITT (OR APPROVED EQUAL)	CONTACT: 800-697-6084 www.muttmitt.com	DOG WASTE STATION -BEST CHOICE	1005	SINGLES, GREEN STATION	INSTALL PER MANUFACTURER SPECIFICATIONS. REFER TO PLANS FOR LOCATION AND QUANTITY

NOTES 1. ALL SITE AMENITIES TO BE PROVIDED BY OWNER.

2. CONTRACTOR TO INSTALL ALL AMENITIES AS DETAILED IN THE PLANS OR PER MANUFACTURER SPECIFICATIONS.

MATERIALS SCHEDULE

MATERIALS SCHEDULE						
ITEM DESCRIPTION	MANUFACTURER	CONTACT	PRODUCT NAME	SIZE / DIMENSIONS	COLOR/FINISH	NOTES
M-101 STANDARD CONCRETE	QUIKCRETE (OR APPROVED EQUAL)	N/A	N/A	REFER TO CIVIL PLANS FOR DETAILS	STANDARD GRAY MEDIUM BROOM FINISH	REFER TO CIVIL FOR DEPTH AND INSTALLATION DETAILS, BROOM FINISH SHALL BE PARALLEL WITH SLOPE TO ENSURE PROPER DRAINAGE
M-102 ENHANCED CONCRETE	QUIKCRETE (OR APPROVED EQUAL)	N/A	N/A	REFER TO CIVIL PLANS FOR DETAILS	DAVIS COLOR, LIGHT GRAY .5 LBS 8084 OR 2.5 LBS 860	REFER TO CIVIL FOR DEPTH AND INSTALLATION DETAILS.
					PROLINE OLD GRANITE 48"X48" SEAMLESS STAMP	
M-103 RECYCLED ASPHALT	PIONEER LANDSCAPE CENTERS	CONTACT: 866.600.0652 www.pioneersand.com	RECYCLED ASPHALT	3/4"	N/A	REFER TO DETAIL 3, SHEET LS-501
M-104 CRUSHER FINES	PIONEER LANDSCAPE CENTERS	CONTACT: 866.600.0652 www.pioneersand.com	BREEZE / MINUS	¹ / ₄ " MINUS	GREY	REFER TO DETAIL 3, SHEET LS-501
M-105 WOOD MULCH	PIONEER LANDSCAPE CENTERS	CONTACT: 866.600.0652 www.pioneersand.com	WASHINGTON CEDAR MULCH	N/A	WASHINGTON CEDAR MULCH	MINIMUM 3" DEPTH, INSTALL PER DETAILS AND SPECIFICATIONS
M-106 PLASTIC EDGER	PIONEER LANDSCAPE CENTERS	CONTACT: 866.600.0652 www.pioneersand.com	EPIC EDGE BENDA BOARD	2" x 6" x 16'	CARAMEL BROWN	REFER TO DETAIL 4, SHEET L-501
M-107 STEPPING STONES	SILOAM STONE, INC. (OR APPROVED EQUAL)	CONTACT: 719.275.4275	STANDARD PALLET	12-24" X 18-36" 1-3" THICK	SIENNA BUFF	REFER TO DETAIL 7, SHEET LS-501
M-108 BOULDERS	BY OWNER	CONTACT:	ROUND BOULDERS TO BE PROVIDED BY OWNER	2' SQ TO 4' SQ BOULDERS	EARTH TONES AND NATURAL GREY	REFER TO DETAIL 8, SHEET LS-501, LANDSCAPE ARCHITECT TO SELECT BOULDERS FROM TOWN STORAGE YARD FOR INSTALLATION ON SITE

NOTES 1. THE MANUFACTURERS AND PRODUCTS LISTED IN AMENITY SCHEDULE AND MATERIAL SCHEDULE ARE THE BASIS OF DESIGN FOR THIS PROJECT. IF A SUBSTITUTION IS SUGGESTED FOR ANY OF THE ABOVE MANUFACTURER DESCRIBED PRODUCTS, THOSE SUBSTITUTIONS WILL NEED TO BE SUBMITTED FOR REVIEW AND ACCEPTED BEFORE ORDERING AND INSTALLATION COMMENCES.

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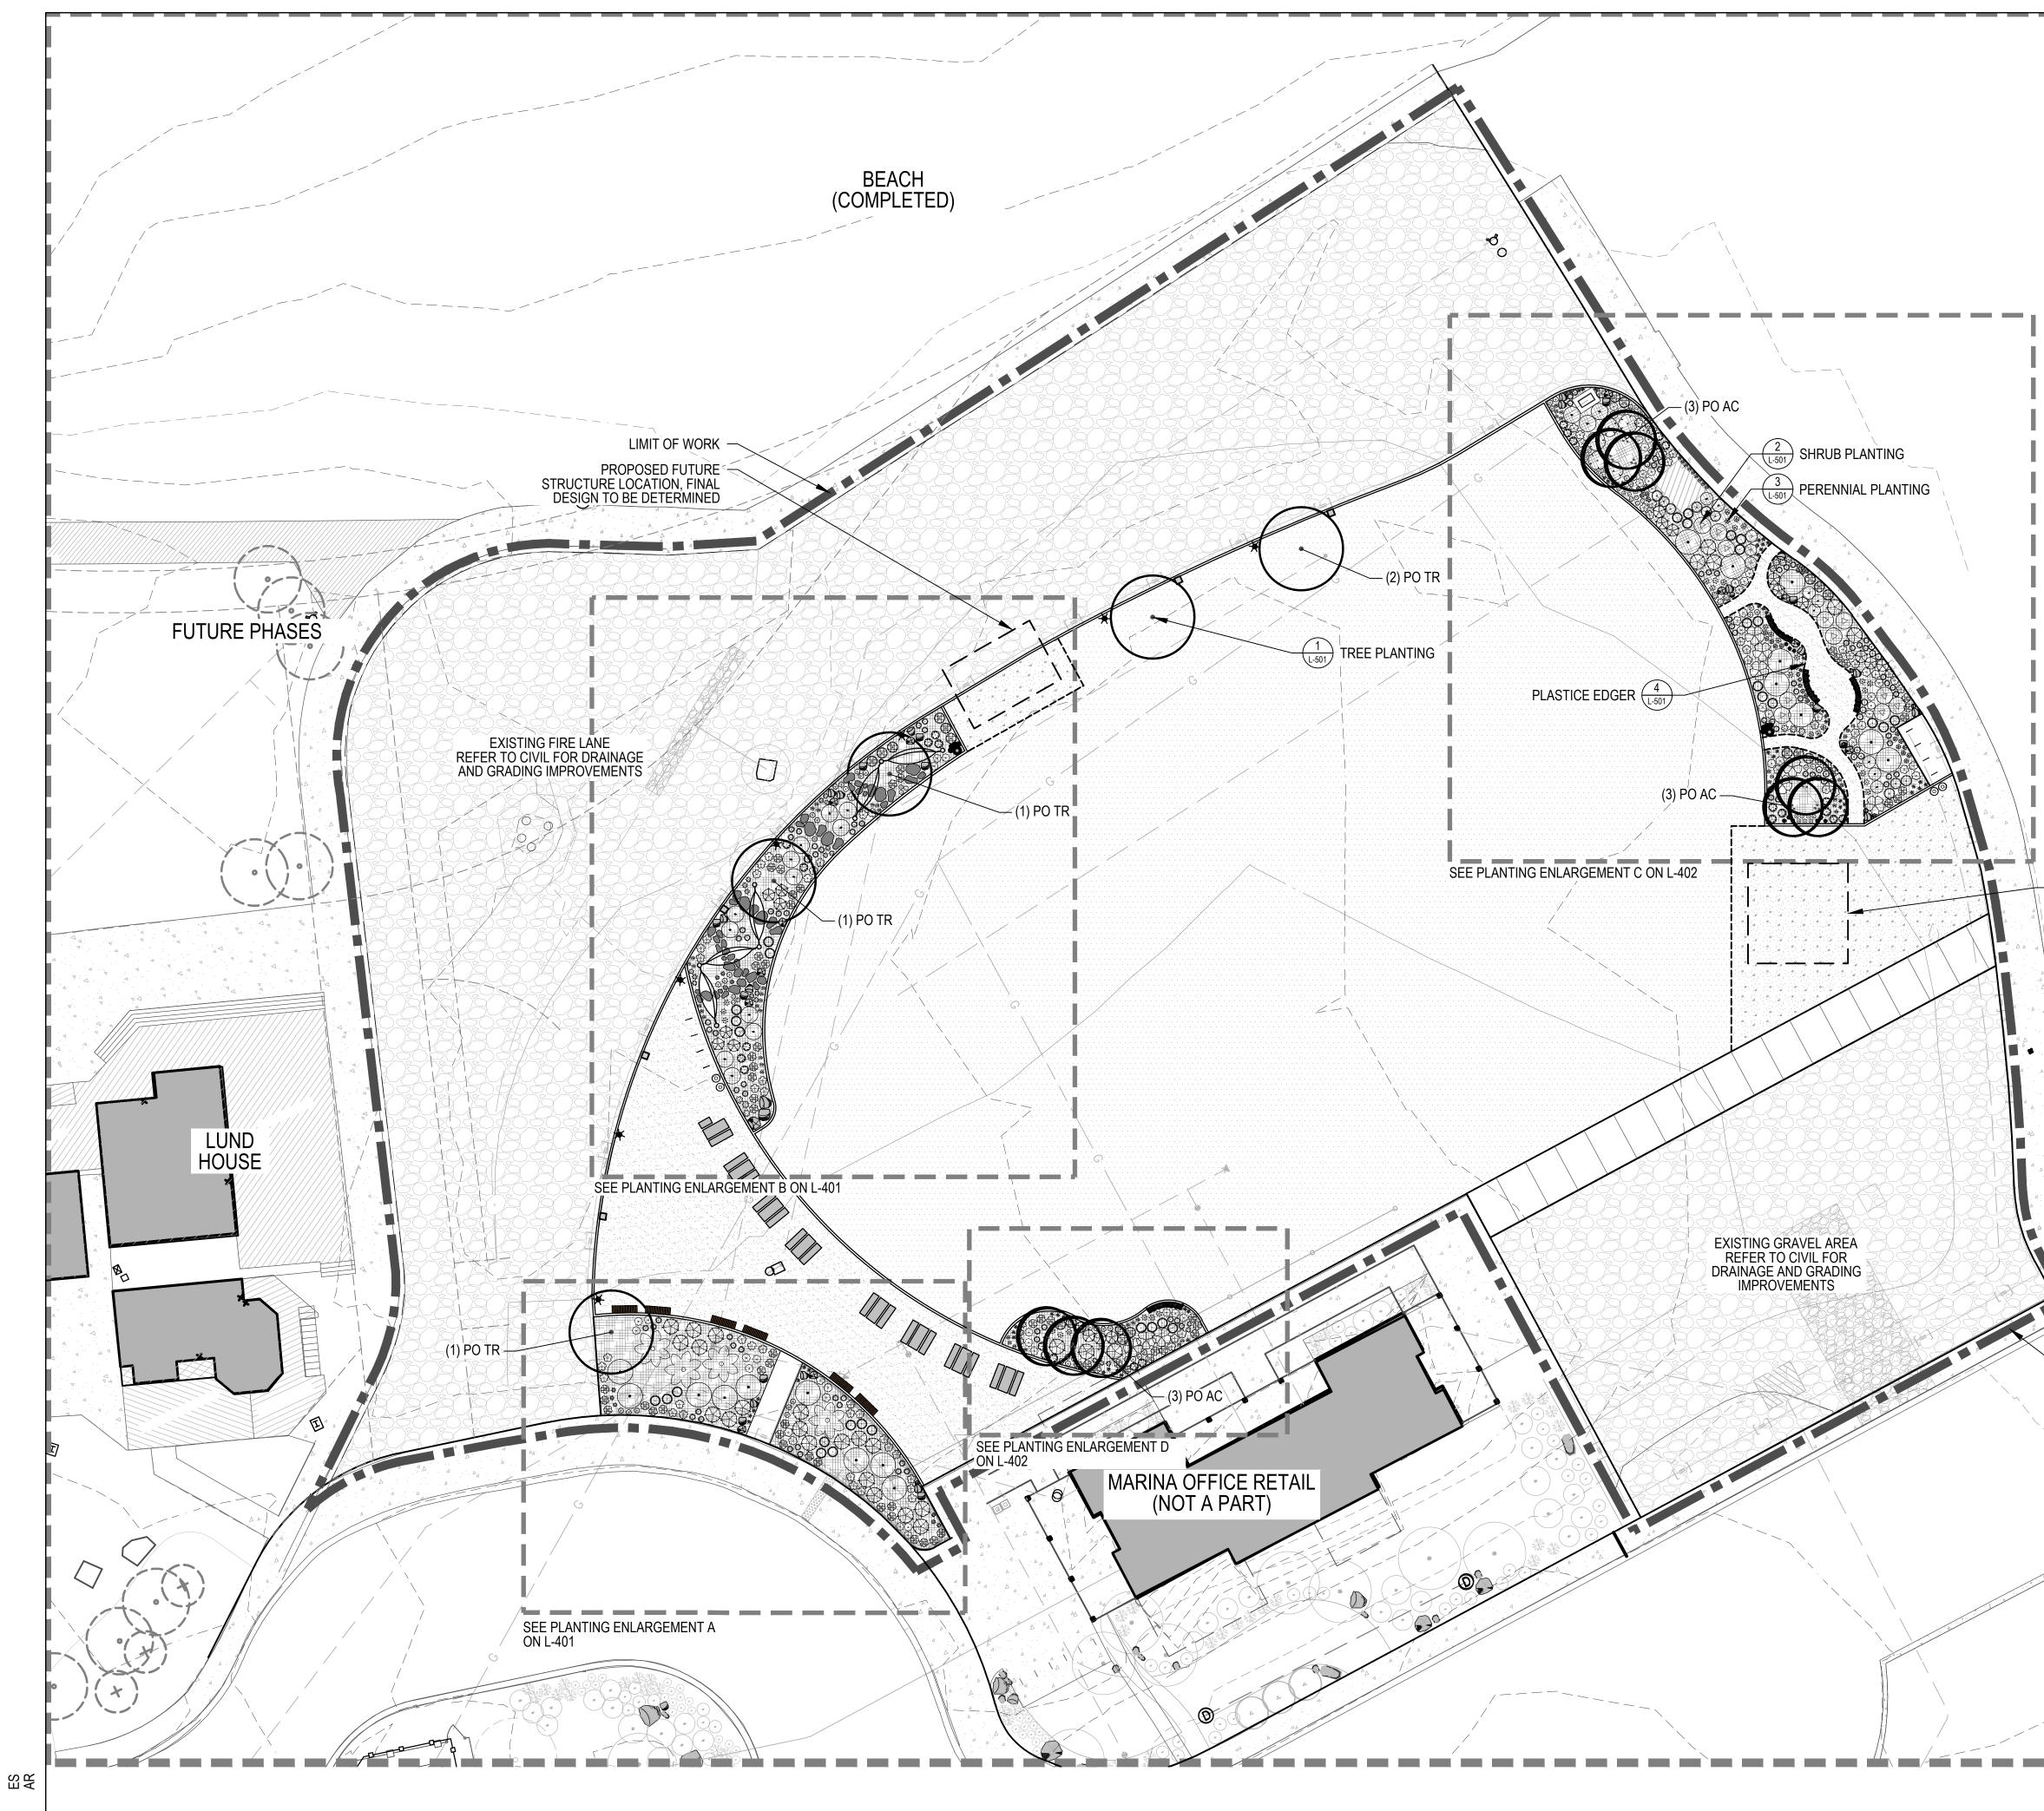
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> SHEET TITLE: LANDSCAPE SCHEDULES

> > L-003




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LIMIT OF WORK

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SCALE 1" = 20'




M-101	STANDARD CONCRETE, DETAI 5/LS-501
<u>/ / / / / / / / / / / / / / / / / / / </u>	ENHANCED CONCRETE
M-103	RECYCLED ASPHALT
M-104	CRUSHER FINES
M-105	WOOD MULCH
	TURF LAWN, L-002
	FIRE LANE MATERIAL TO BE REPLACED AS NECESSARY


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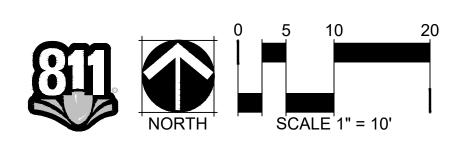
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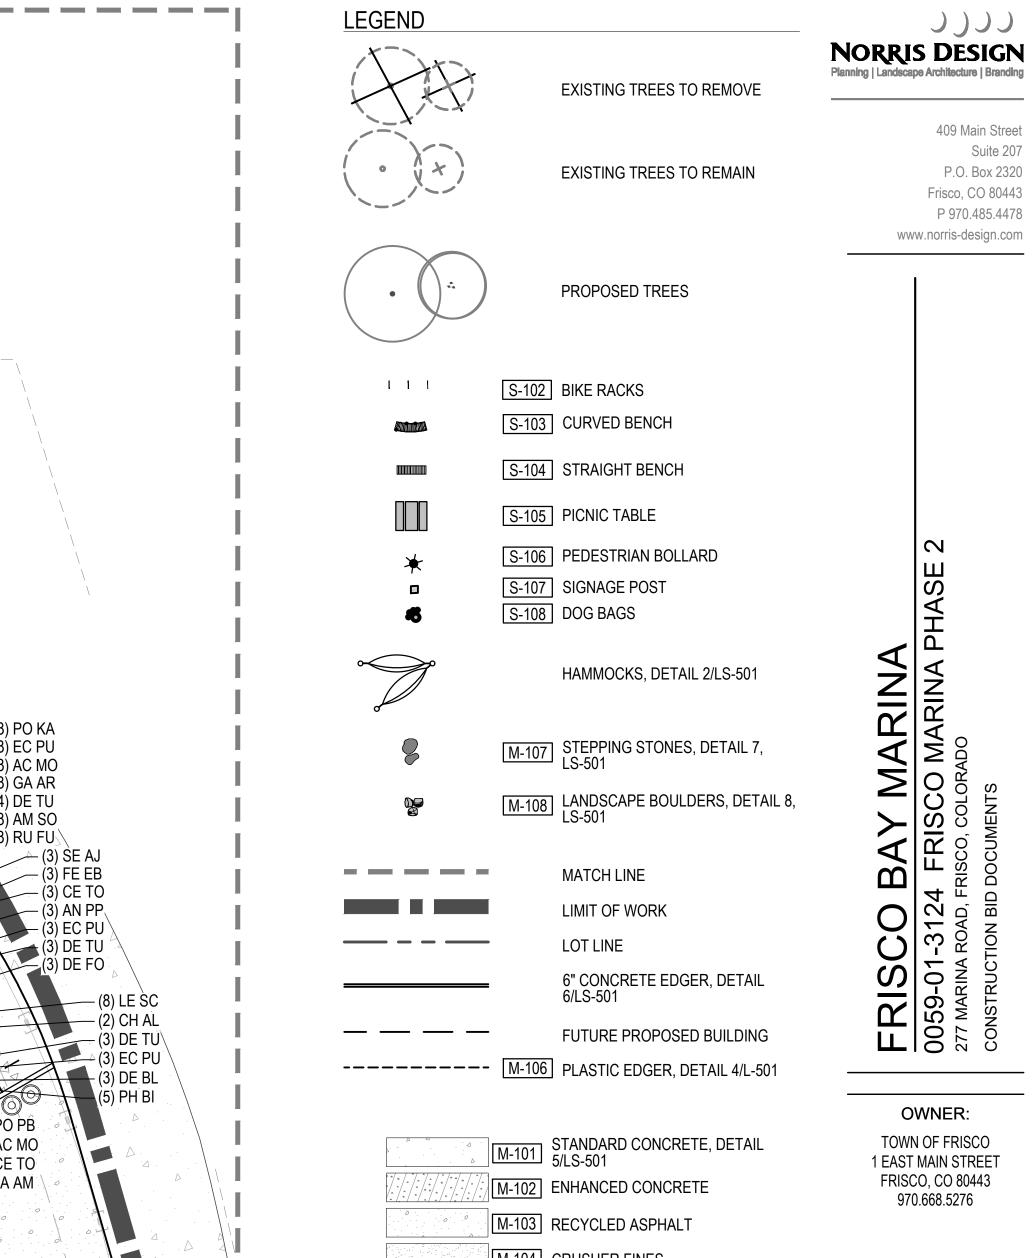


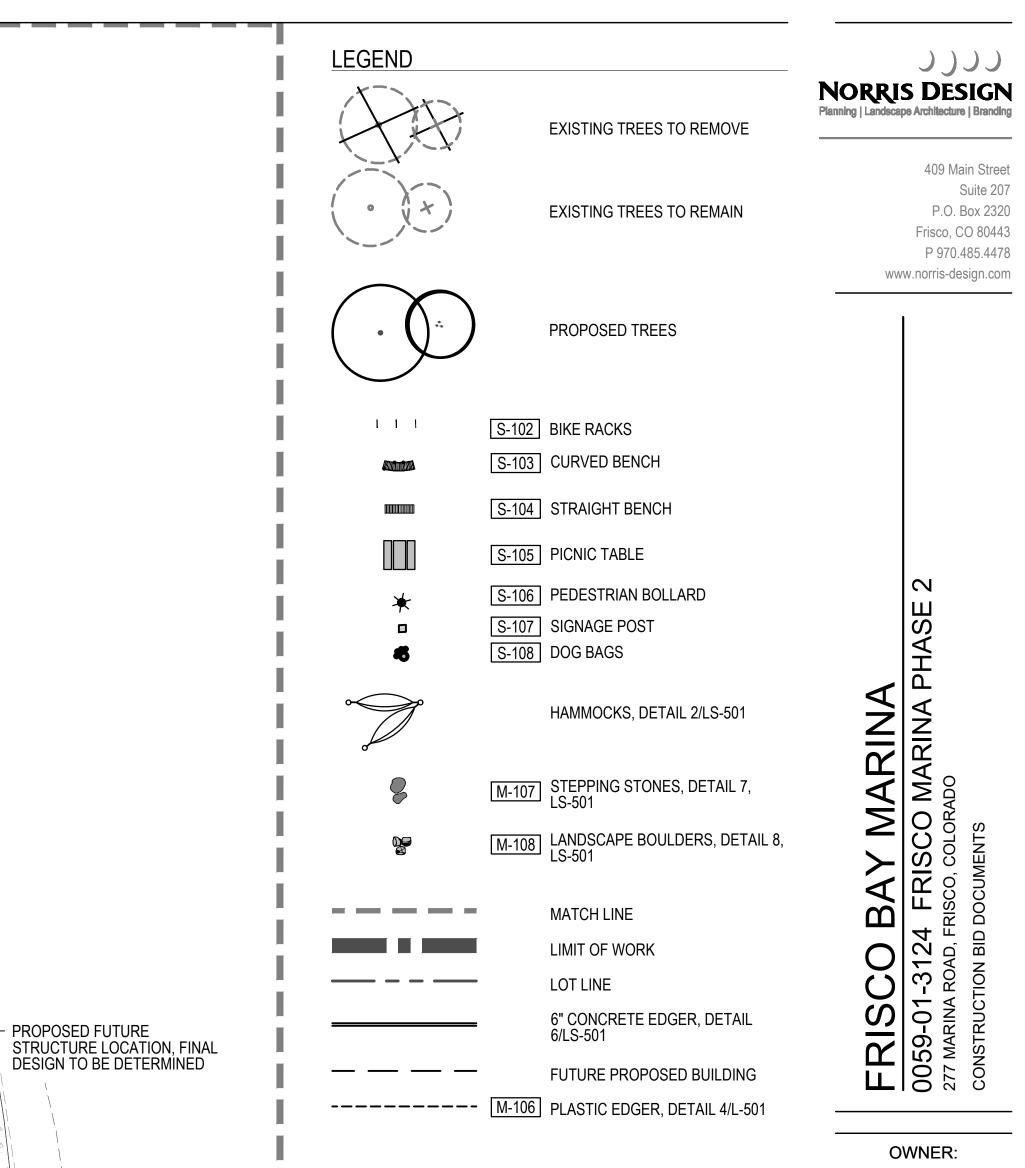ENLARGEMENT A

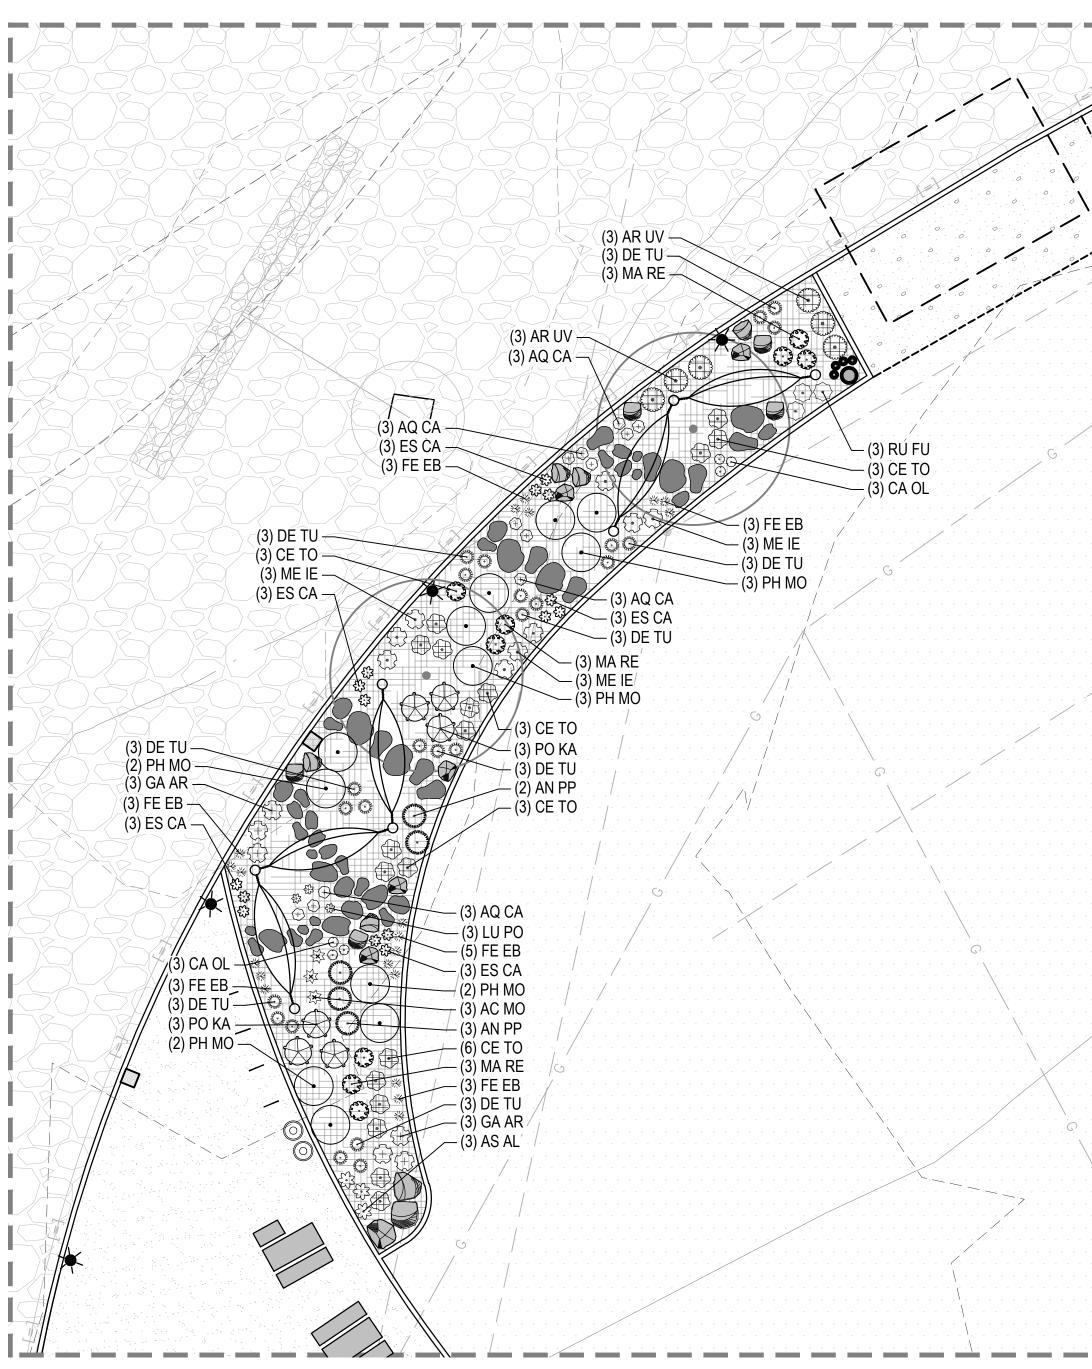

ENLARGEMENT B



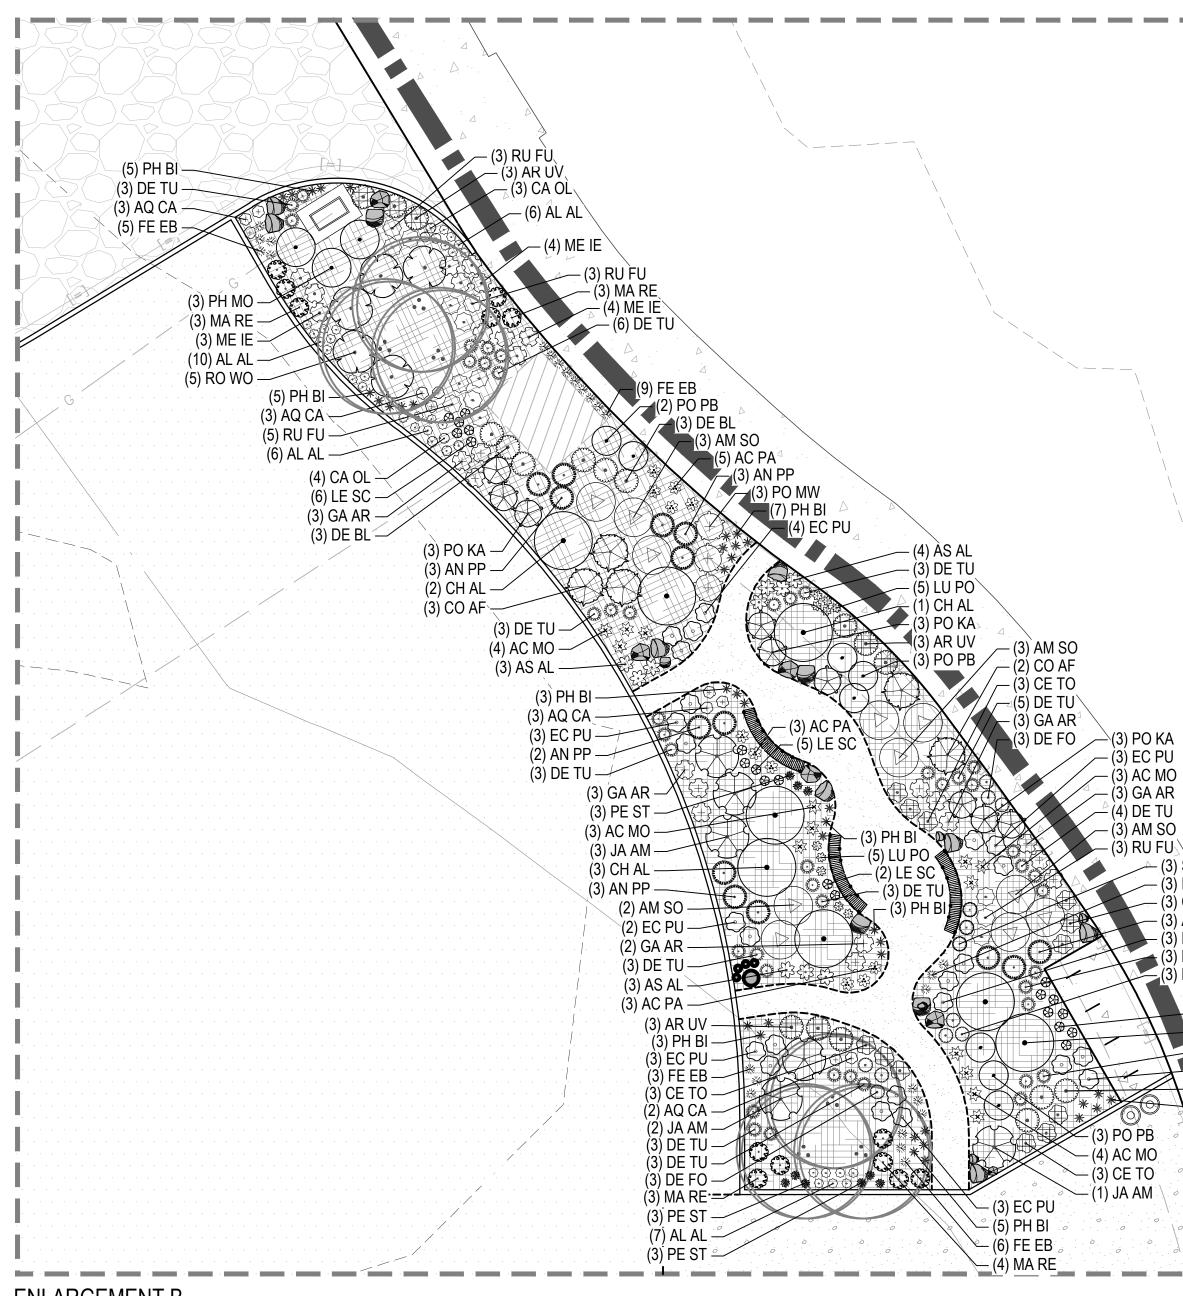

	FUTURE PROPOSED BUILDING
—————— M-106	PLASTIC EDGER, DETAIL 4/L-50
M-101	STANDARD CONCRETE, DETAIL 5/LS-501
<u>/////////////////////////////////////</u>	ENHANCED CONCRETE
^о	RECYCLED ASPHALT
M-104	CRUSHER FINES
M-105	WOOD MULCH
	TURF LAWN, L-002
	FIRE LANE MATERIAL TO BE REPLACED AS NECESSARY



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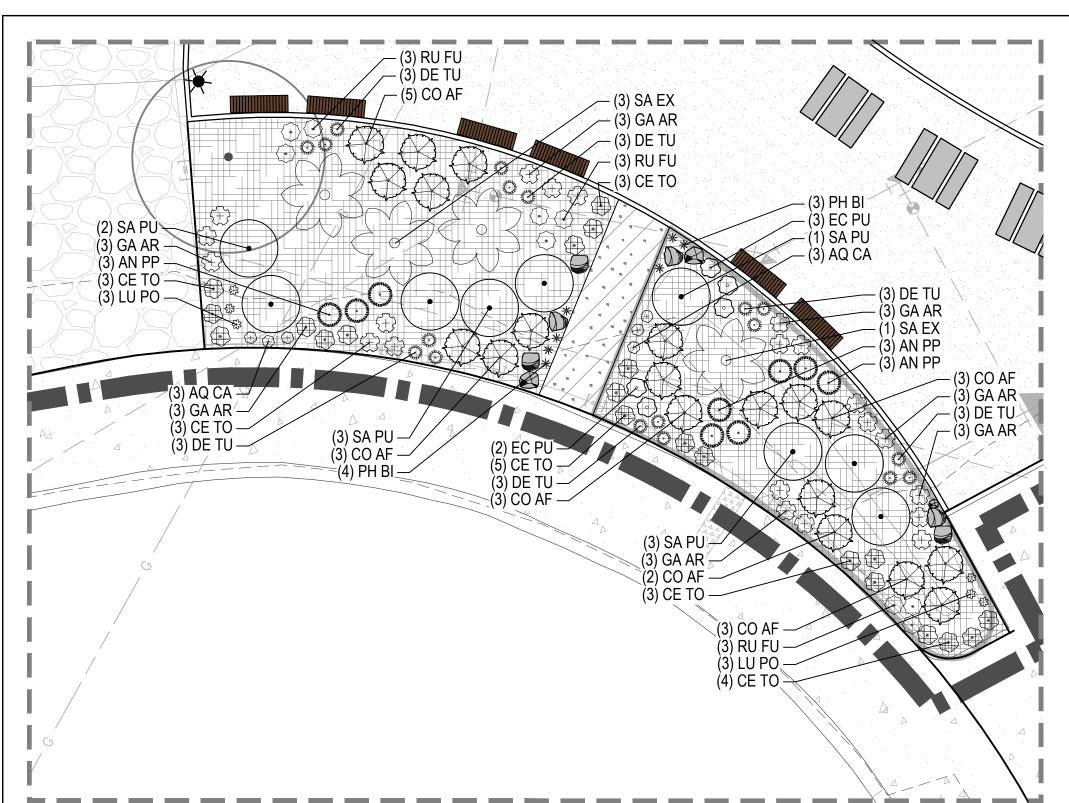
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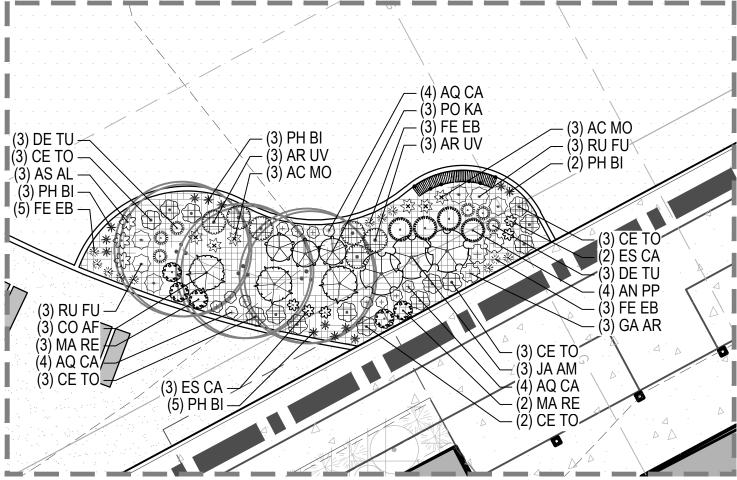
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SHEET TITLE: PLANTING ENLARGEMENTS


L-401







ENLARGEMENT D

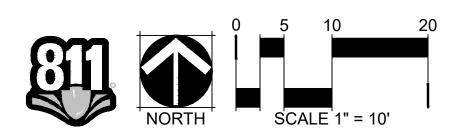

LEGEND		
(T)	EXISTING TREES TO REMOVE	NORRIS DESIGN Planning Landecape Architecture Branding
	EXISTING TREES TO REMAIN	409 Main Street Suite 207 P.O. Box 2320 Frisco, CO 80443 P 970.485.4478
•	PROPOSED TREES	www.norris-design.com
	S-102 BIKE RACKS	
	S-103 CURVED BENCH	
	S-104 STRAIGHT BENCH	
	S-105 PICNIC TABLE	
* • *	S-106PEDESTRIAN BOLLARDS-107SIGNAGE POSTS-108DOG BAGS	HASE 2
	HAMMOCKS, DETAIL 2/LS-501	ARINA MARINA PHASE
Ş	M-107 STEPPING STONES, DETAIL 7, LS-501	MARIN ORADO IS
	M-108 LANDSCAPE BOULDERS, DETAIL 8, LS-501	FRISCO BAY MA 0059-01-3124 FRISCO M 277 MARINA ROAD, FRISCO, COLORADC CONSTRUCTION BID DOCUMENTS
	MATCH LINE	
	LIMIT OF WORK	CO
	LOT LINE	
	6" CONCRETE EDGER, DETAIL 6/LS-501	FRIS 059-01 7 MARINA
	FUTURE PROPOSED BUILDING	
	- M-106 PLASTIC EDGER, DETAIL 4/L-501	
	M-101 STANDARD CONCRETE, DETAIL 5/LS-501 M-102 ENHANCED CONCRETE	OWNER: TOWN OF FRISCO 1 EAST MAIN STREET FRISCO, CO 80443 970.668.5276

M-101	STANDARD CONCRETE, DETAIL 5/LS-501
<u>/////////////////////////////////////</u>	ENHANCED CONCRETE
M-103	RECYCLED ASPHALT
M-104	CRUSHER FINES
M-105	WOOD MULCH
	TURF LAWN, L-002
	FIRE LANE MATERIAL TO BE REPLACED AS NECESSARY

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PRUNING NOTES:

ALL PRUNING SHALL COMPLY WITH ANSI A300 STANDARDS.

2. DO NOT HEAVILY PRUNE TREE AT PLANTING. PRUNE ONLY CROSSOVER LIMBS, CO-DOMINANT LEADERS AND BROKEN BRANCHES. SOME INTERIOR TWIGS AND LATERAL BRANCHES MAY BE PRUNED. HOWEVER, DO NOT REMOVE THE TERMINAL BUDS OF BRANCHES THAT EXTEND TO THE EDGE OF THE CROWN.

STAKING NOTES:


TREE PLANTING


1. STAKE TREES PER DIAGRAM. AFTER A MINIMUM OF (3) THREE YEARS CONFIRM TREE IS ESTABLISHED. CHECK FOR ROOTBALL STABILITY. APPLY HAND PRESSURE TO TRUNK OF TREE, WHEN ROOTBALL DOES NOT MOVE, REMOVE STAKING.

- a. 2" CALIPER SIZE AND UNDER DECIDUOUS AND ASPEN TREES MINIMUM 2 STAKES ONE ON N.W. SIDE, ONE ON S.W. SIDE (OR PREVAILING WIND SIDE AND 180° FROM THAT SIDE). b. EVERGREEN TREES - 3 STAKES PER DIAGRAM.
- c. 3" CALIPER SIZE AND LARGER 3 STAKES PER DIAGRAM.

2. WIRE OR CABLE SHALL BE MINIMUM 12 GAUGE, TIGHTEN WIRE OR CABLE ONLY ENOUGH TO KEEP FROM SLIPPING. ALLOW FOR SOME TRUNK MOVEMENT. NYLON STRAPS SHALL BE LONG ENOUGH TO ACCOMMODATE 1-1/2" OF GROWTH AND BUFFER ALL BRANCHES FROM WIRE. ADJUST STAKING, STRAPS AND GUY WIRES ANNUALLY.

TREATED WOOD POST PREFERRED. METAL T STAKES WITH PLASTIC SAFETY CAPS ACCEPTABLE WITH APPROVAL FROM OWNER.

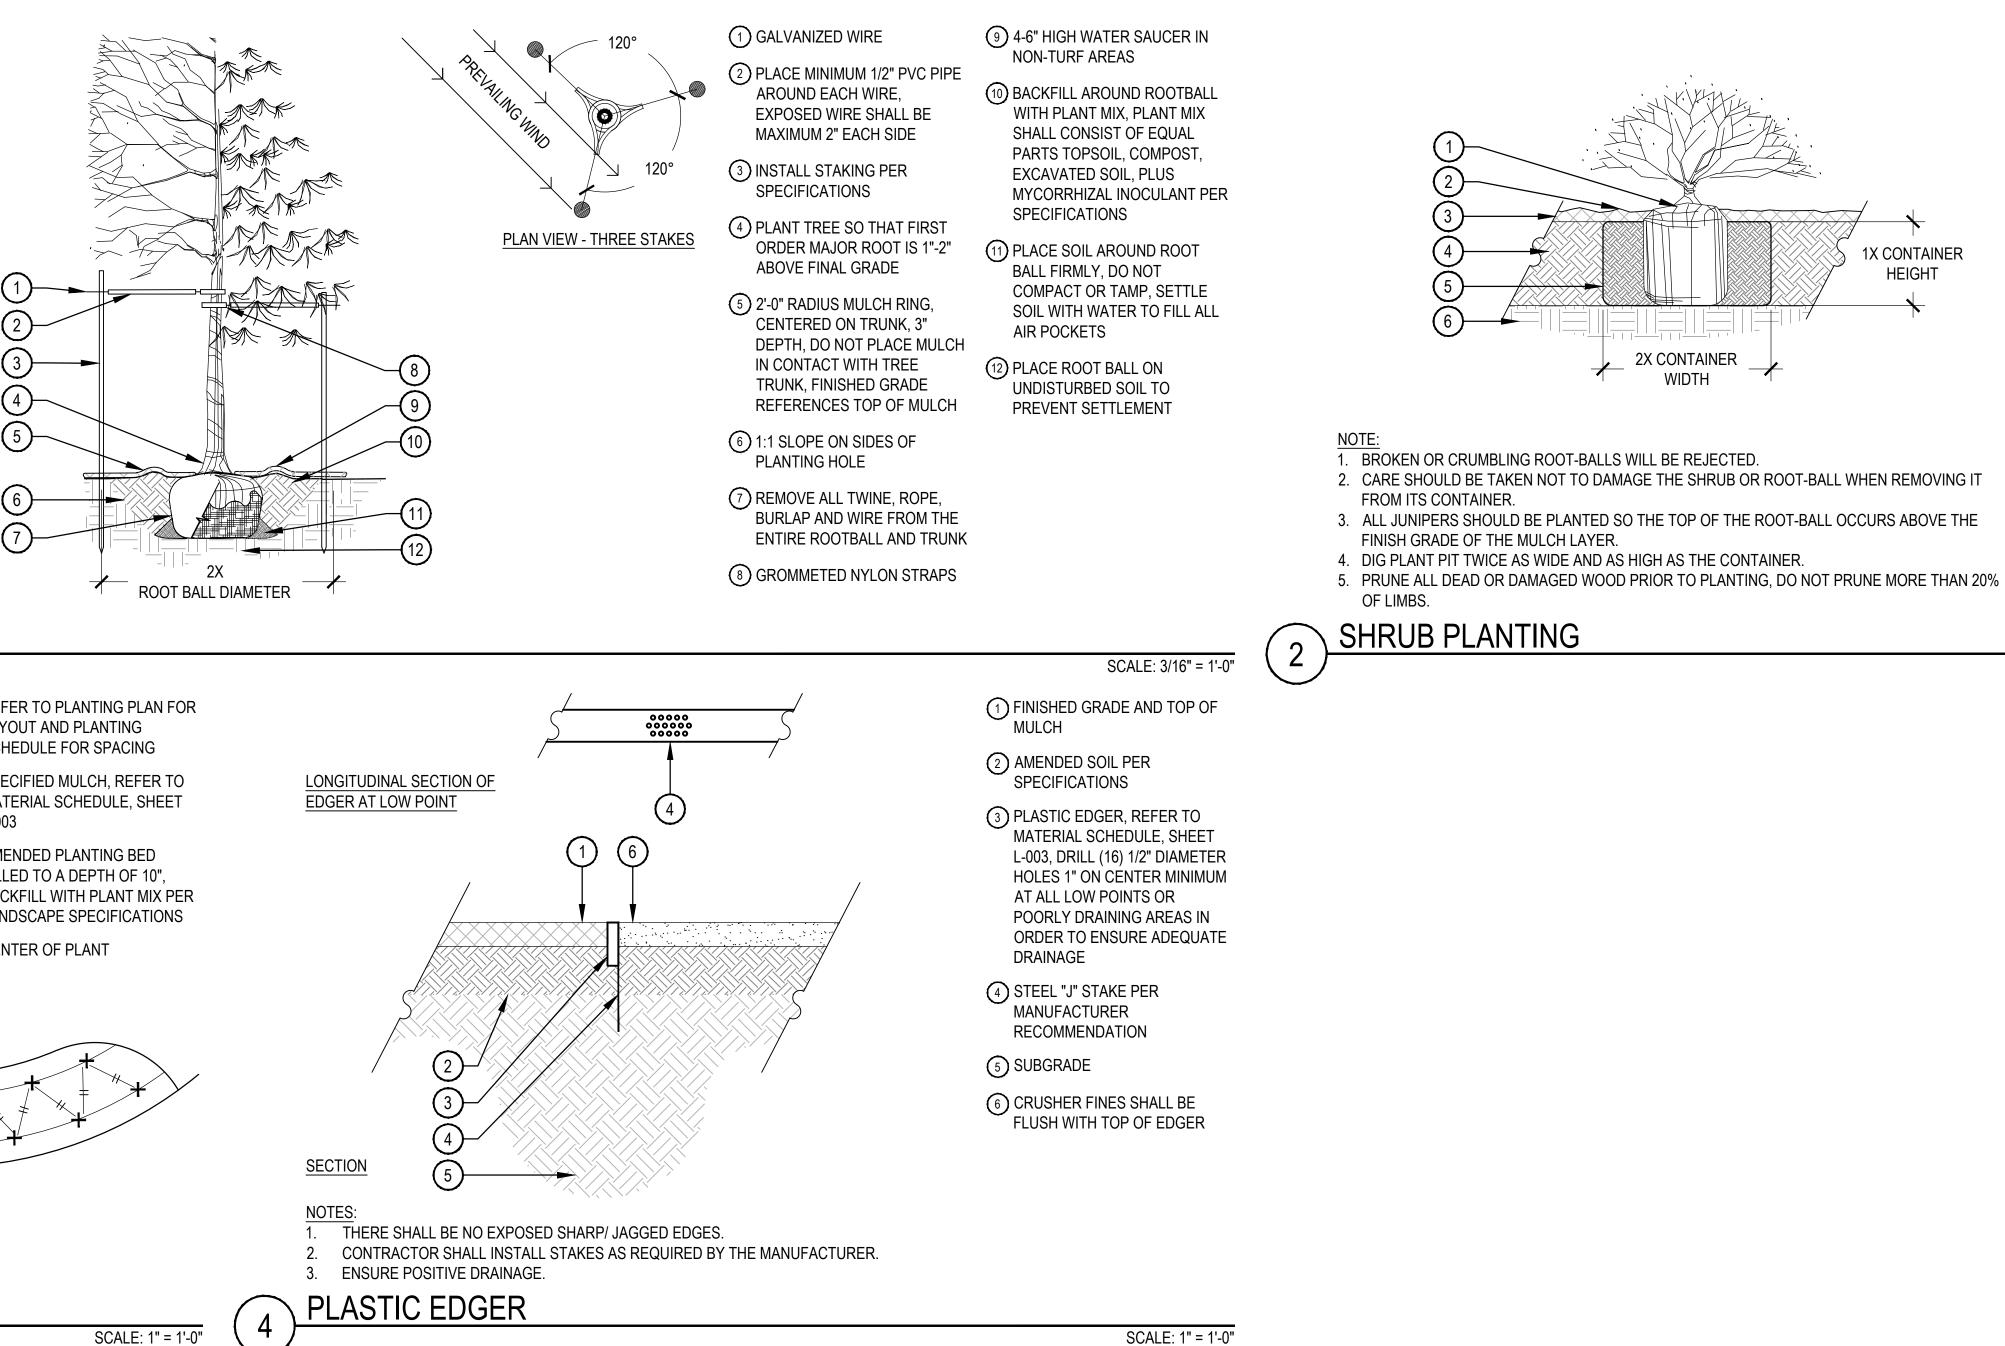

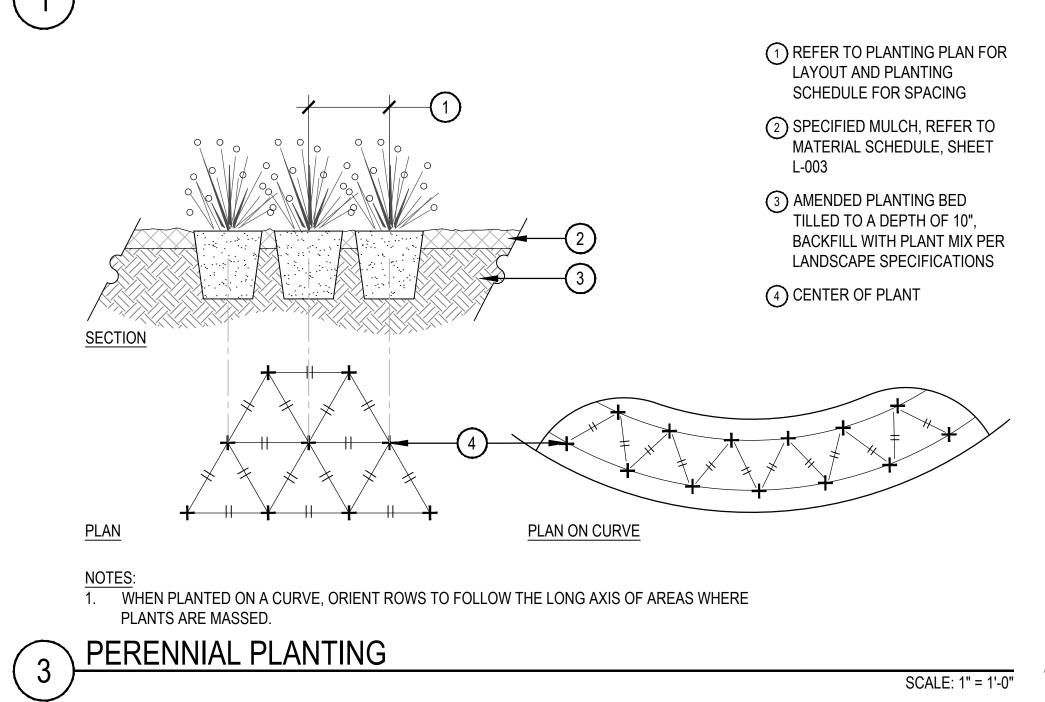

- (1) SET SHRUB ROOT-BALL 1" HIGHER THAN FINISH GRADE
- (2) FINISH GRADE (TOP OF MULCH)
- (3) SPECIFIED MULCH, REFER TO MATERIAL SCHEDULE, SHEET L-003
- (4) TILL IN SPECIFIED SOIL AMENDMENT TO A DEPTH OF 8" IN BED
- (5) BACKFILLED AMENDED SOIL
- 6 UNDISTURBED SOIL

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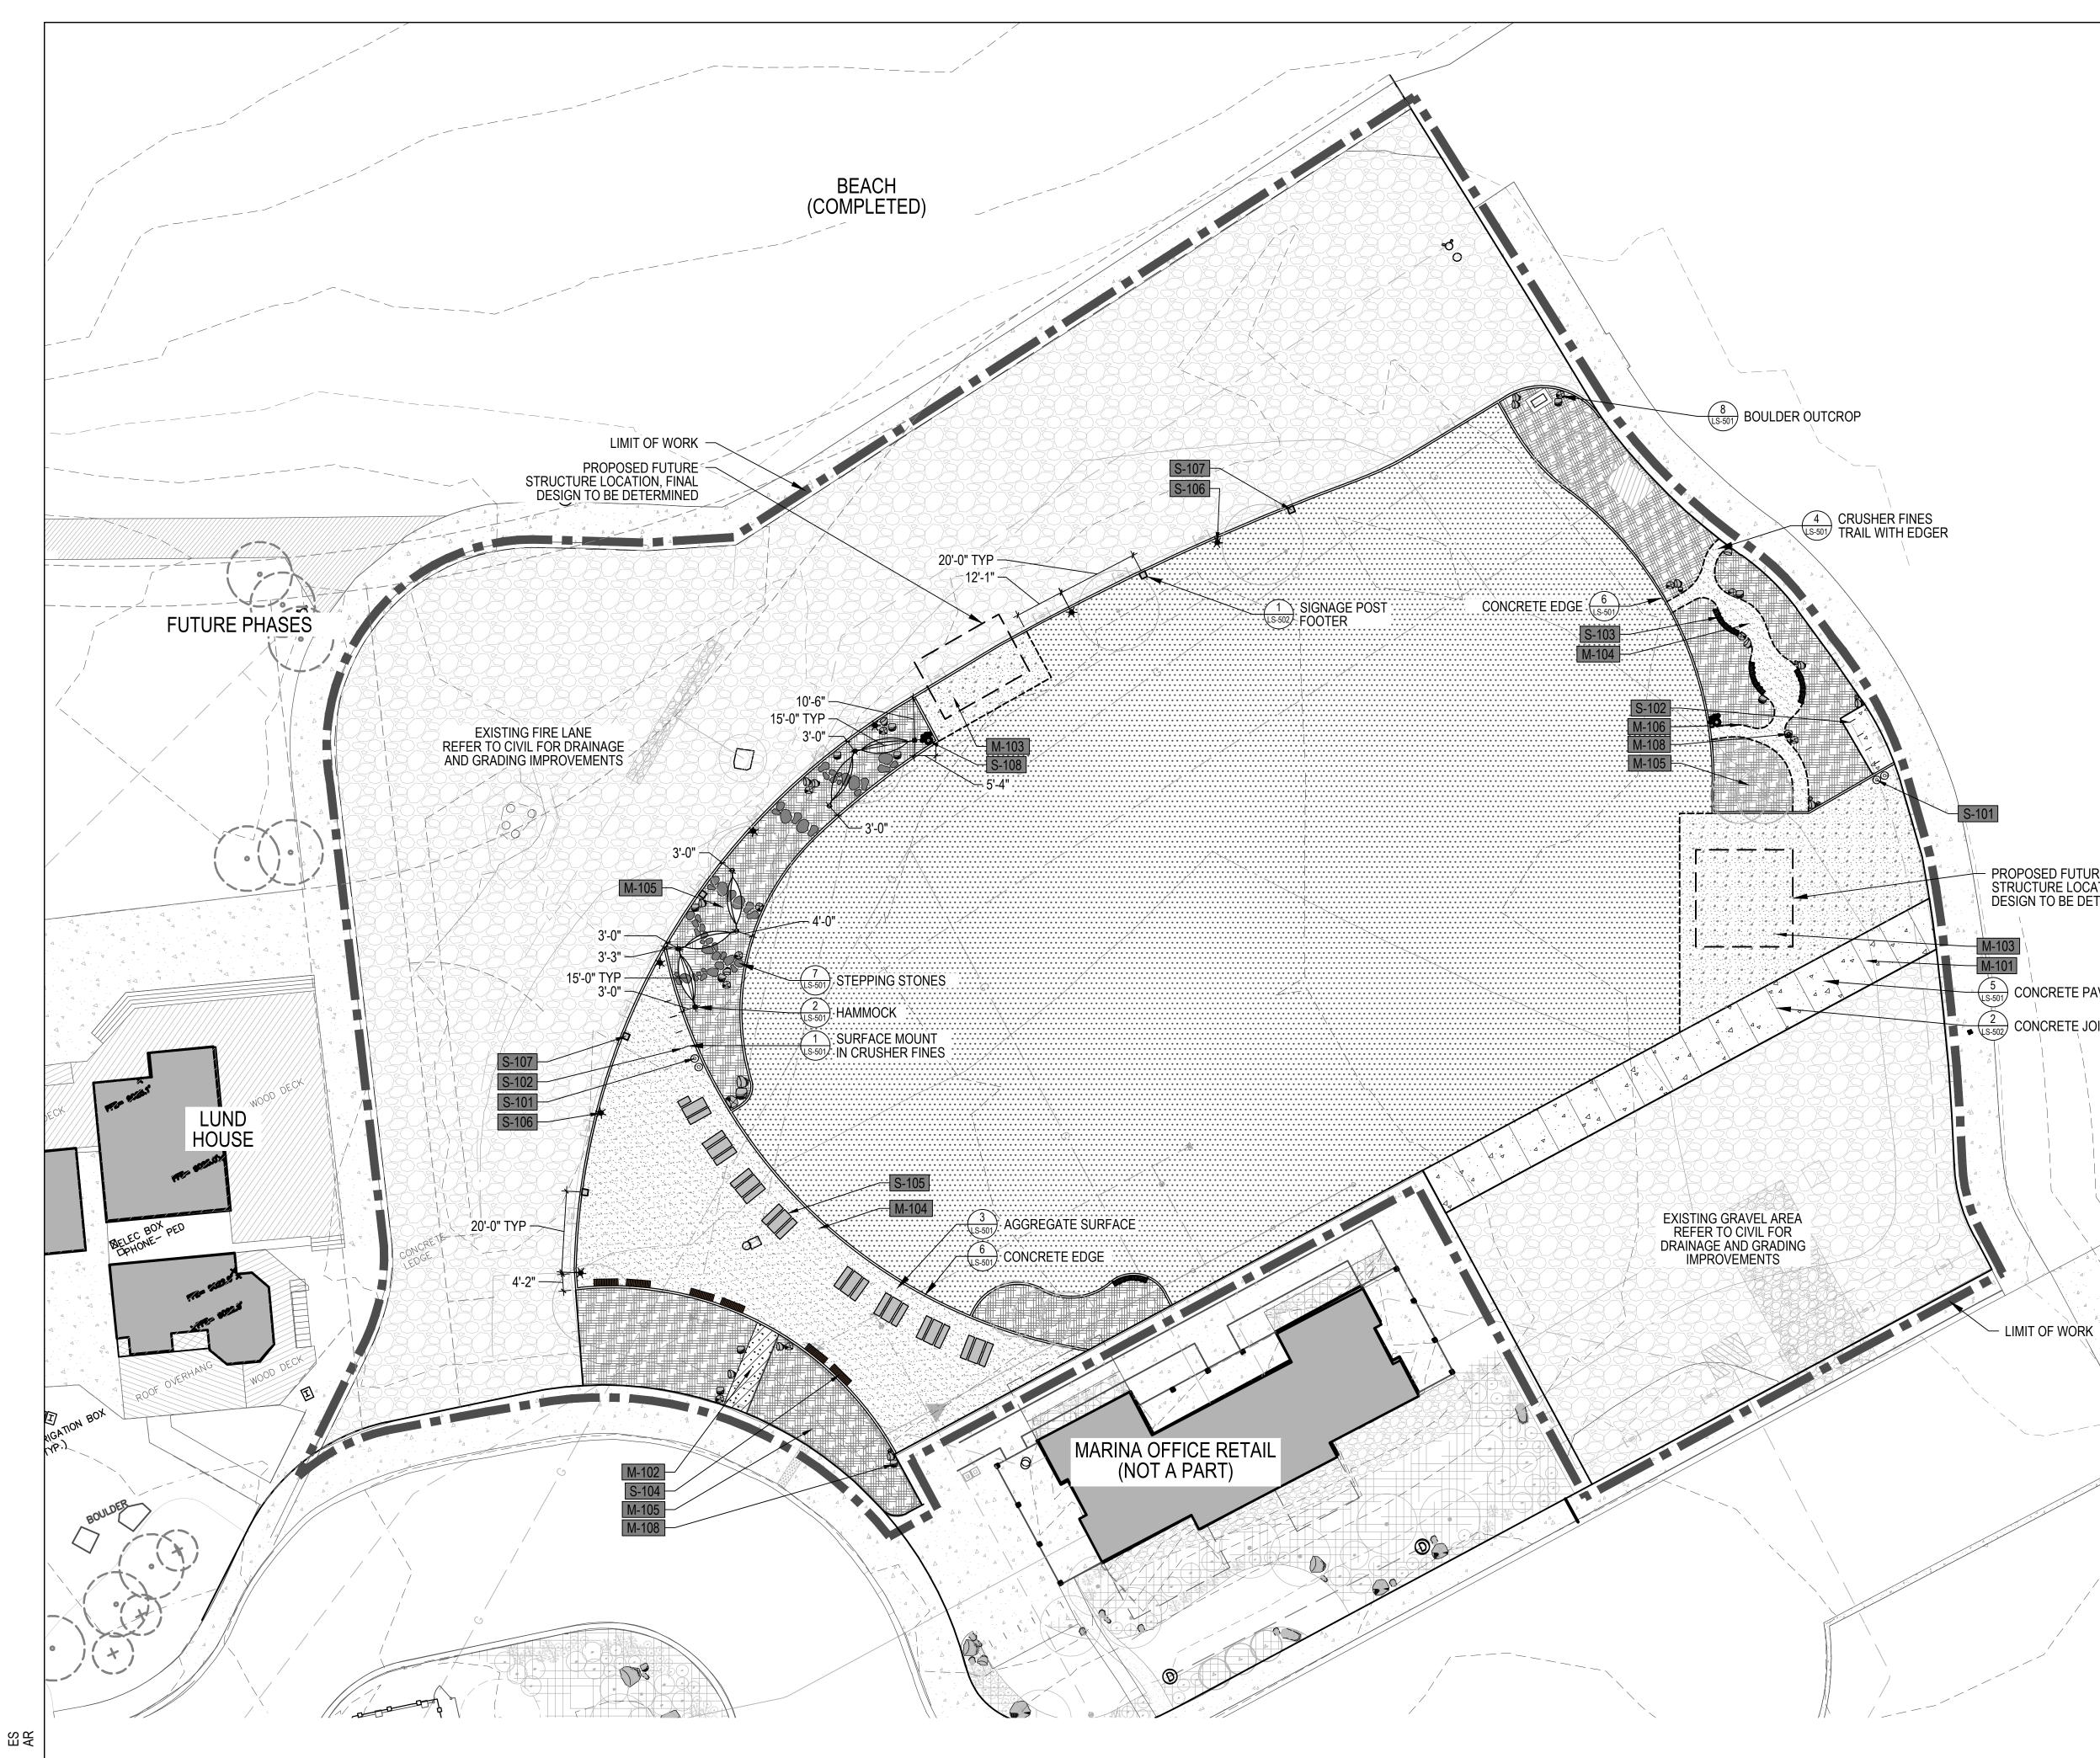
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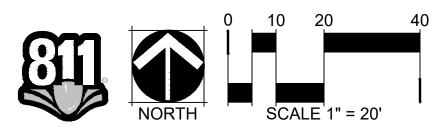
> SHEET TITLE: LANDSCAPE DETAILS




SCALE: 1 1/2" = 1'-0"



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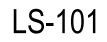



TURF LAWN, L-002

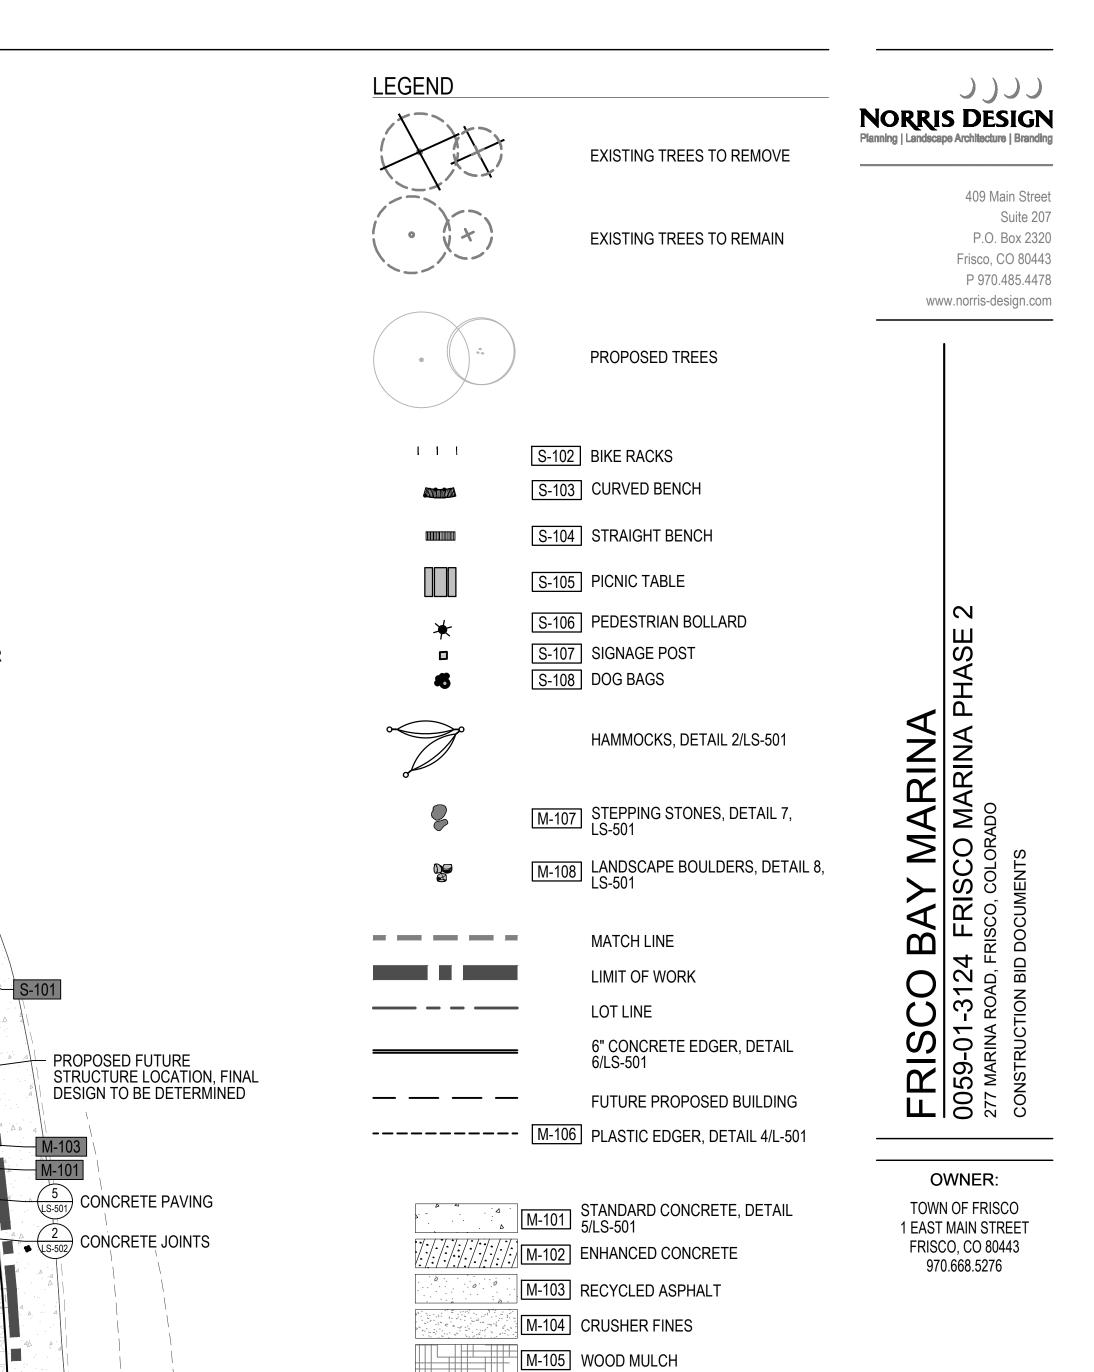FIRE LANE MATERIAL TO BE REPLACED AS NECESSARY

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> > SHEET TITLE: HARDSCAPE PLAN




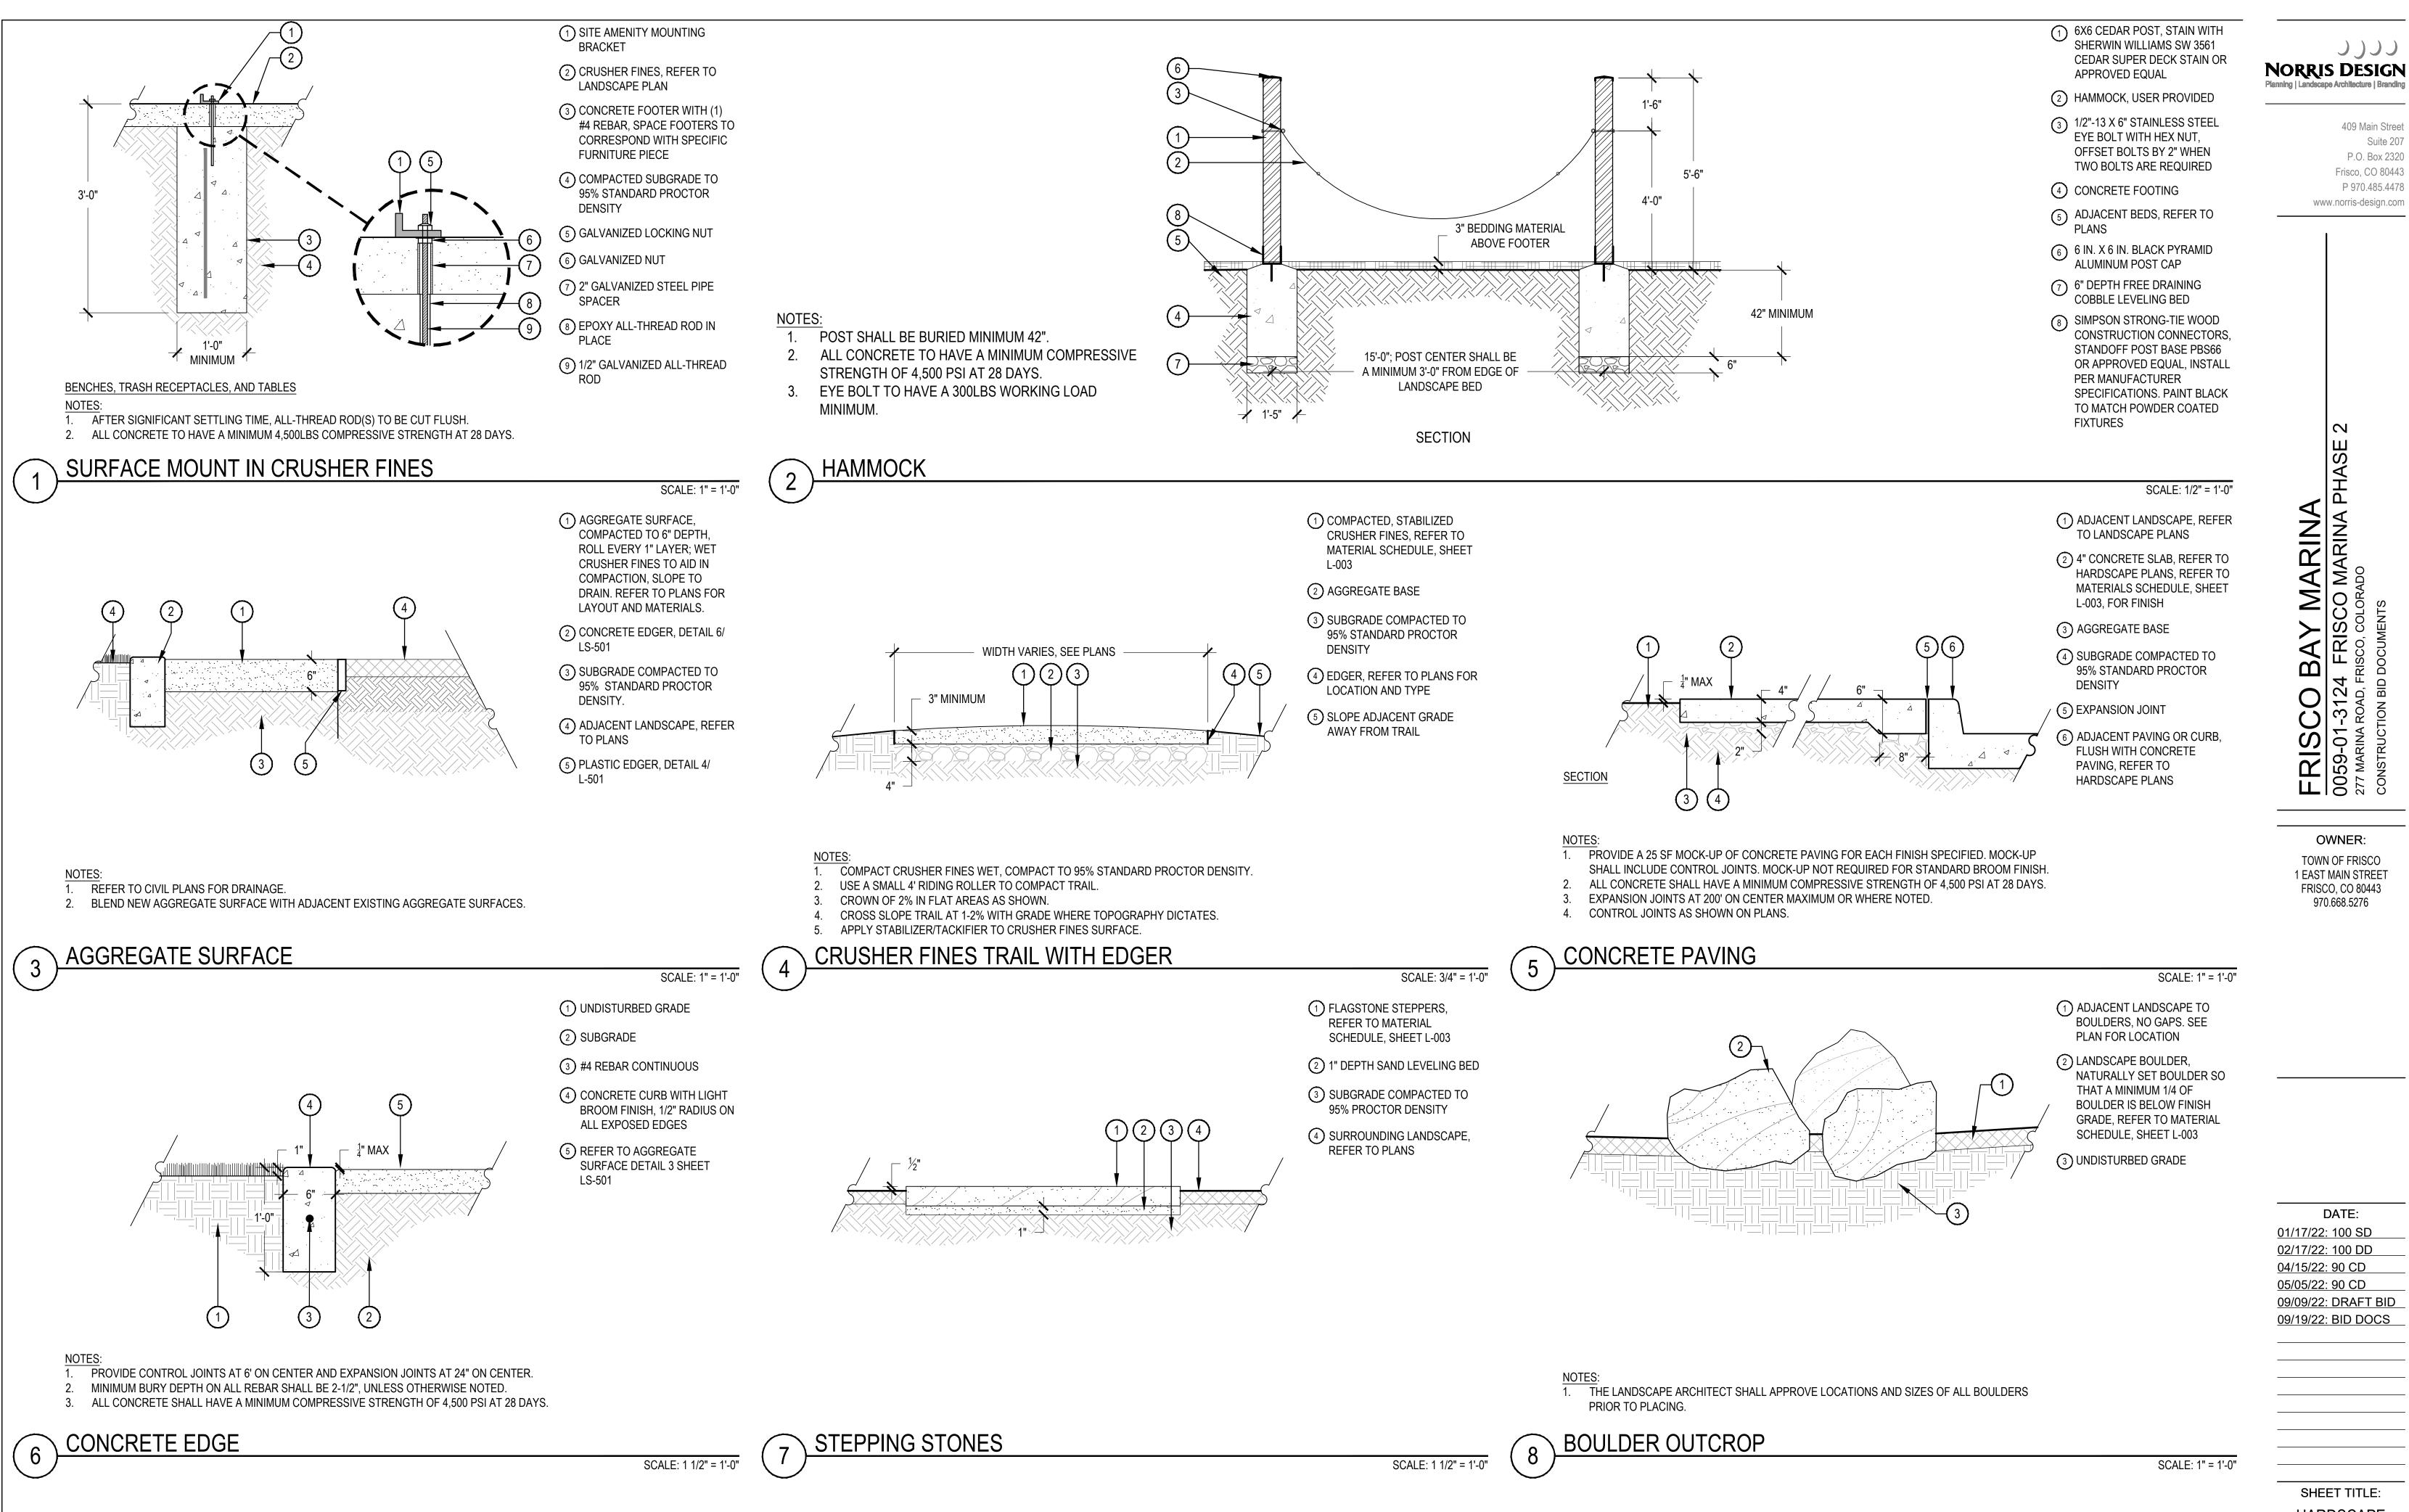

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HARDSCAPE DETAILS

LS-501

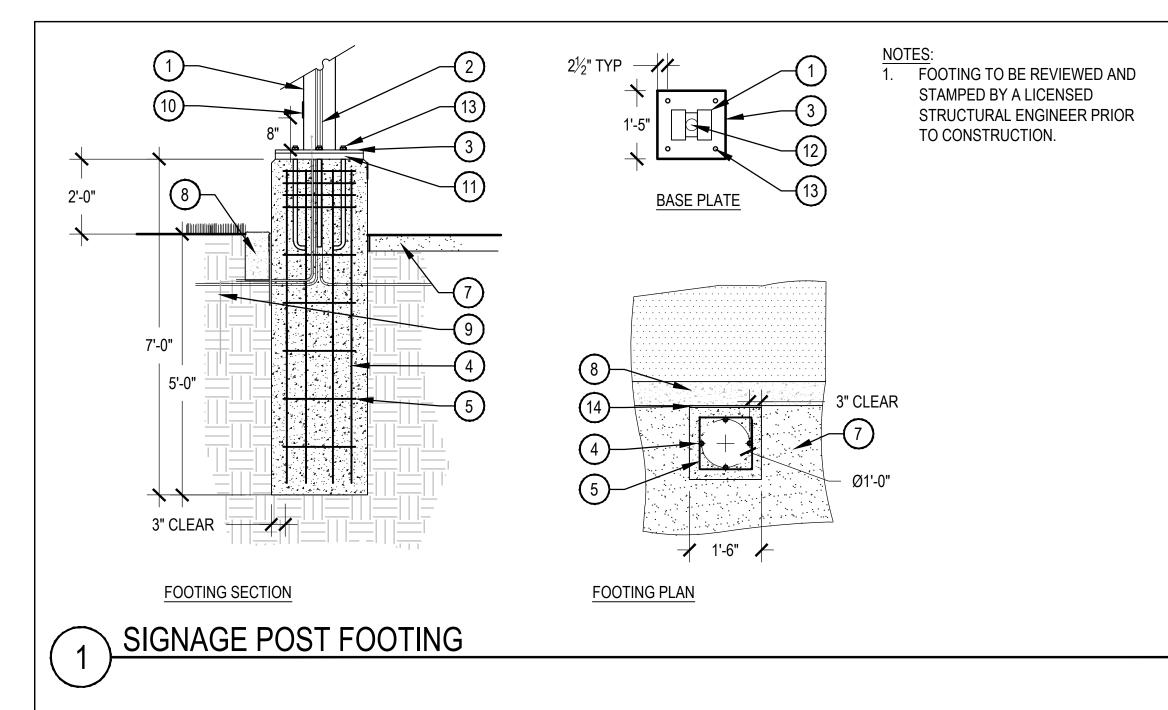



1 SIGNAGE POST BY OWNER

- 2 ELECTRICAL CONDUIT, REFER TO ELECTRICAL
- 3 17" x 17" x 3/4" BASE PLATE
- (4) (8) # 5 VERTICAL REBAR, GRADE 60 MINIMUM
- 5 # 3 REBAR HOOPS, GRADE 60 MINIMUM, (4) 3" C/C TOP THEN (5) 12" C/C TO BOTTOM
- 6 CABLE ATTACHMENT, 3/8" STEEL PLATE, 3/16" CONTINUOUS WELDS
- 7 ADJACENT SURFACE, REFER TO PLANS
- (8) ADJACENT CONCRETE CURB
- (9) GROUND WIRE WITH SEPARATE CONDUIT THROUGH BASE, REFER TO ELECTRICAL
- 2"x4" HAND HOLE ACCESS, GASKETED METAL COVER 8" ABOVE BASE AND BELOW TOP.
- (1) 1 1/2" GROUT
- 12 3" ACCESS HOLE
- (4) 3/4" Ø F1554 ANCHOR RODS EMBEDDED 12" INTO CONCRETE FOOTING

SCALE: 1/2" = 1'-0"

(14) EXPANSION JOINT, DETAIL 2/ LS501

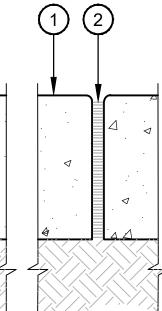

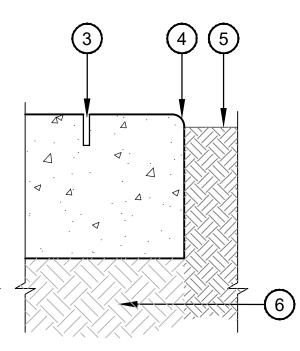

NOTES:

1. C.I.P. CONCRETE PER PLANS AND SPECIFICATIONS.

2. CONTROL JOINTS AS NOTED ON PLANS WITH EXPANSION JOINTS @ 24' O.C. MAX. OR WHERE NOTED.

2 CONCRETE JOINTS

- CONCRETE PAVING FINISH AS NOTED ON PLANS
- FIBER EXPANSION JOINT W/ TRAFFIC SEALANT
- 3 SAW CUT JOINT, 1/8" x 2" DEPTH. DRY CUT JOINT TO AVOID SPALLING. JOINTS SHALL BE CUT BETWEEN 24-48 HOURS OF INSTALLATION
- (4) 1/4" RADIUS TOOL EDGE
- 5 FINISHED GRADE OF LANDSCAPE AREA. BACKFILL AFTER FORM REMOVAL.
- 6 COMPACTED SUBGRADE, 95% STANDARD PROCTOR DENSITY - SEE GEOTECHNICAL REPORT FOR FURTHER INFORMATION

7 1/8" RADIUS

SCALE: 3" = 1'-0"

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> SHEET TITLE: HARDSCAPE DETAILS

> > LS-502

SYMBOL	DESCRIPTION	MODEL NO. DESCRIPTION				ETAIL
М	IRRIGATION METER	1" DEDICATED IRRIGATION MET REFER TO CIVIL, UTILITY, AND V			NA	NA
С	IRRIGATION CONTROLLER	RAINMASTER RME24EGP-ICENT IN STAINLESS STEEL PEDESTAI 120VAC POWER REQUIRED - SE	RAL-SPED-T _ ENCLOSURE	ON	1	LI-501
	RAIN SENSOR	RAINMASTER RM-WETHER-ETR REFER TO CONTROLLER NOTES	-		2	LI-501
	BACKFLOW PREVENTER	1" WILKINS 975XL2 SEE ENCLOSURE SPECIFICATIO	NS BELOW		8	LI-502
NOT SHOWN	SECURITY ENCLOSURE	GUARD SHACK GS-1 LIFT OFF E WITH FROSTGUARD BLANKET, F		ERT TAN	9	LI-502
00	MANUAL DRAIN VALVE	MATCO-NORCA 1/2" 201X INSTALLED IN HIGHLINE 10" ROU	JND VALVE BOX		1	LI-503
0	QUICK COUPLER	TORO 100-SLSC INSTALLED IN HIGHLINE 10" ROU	JND VALVE BOX		5	LI-501
	MASTER VALVE	TORO P-220-26-04 INSTALLED IN HIGHLINE 12" STA	NDARD VALVE BOX		3	LI-501
FS	FLOW SENSOR	FLOWMEC QS-200-10 WITH SHIELDED COMMUNICATION IN HIGHLINE 12" STANDARD VAL		ONTROLLER, INSTALLED	4	LI-501
M	ISOLATION GATE VALVE	MATCO-NORCA 514TX MATCH LINE SIZE, INSTALLED IN	I HIGHLINE 10" ROUND	VALVE BOX	6	LI-501
Ð	TURF VALVE ASSEMBLY	TORO P-220-26-04 WITH SCH 40 BALL VALVE, INSTA SIZED PER PLAN	/ITH SCH 40 BALL VALVE, INSTALLED IN HIGHLINE 12" STANDARD VALVE BOX,			
\oplus	DRIP VALVE ASSEMBLY	TORO DZK-EZF WITH SCH 40 BALL VALVE, INST/ SIZED PER PLAN	VITH SCH 40 BALL VALVE, INSTALLED IN HIGHLINE 18" JUMBO VALVE BOX,			
19 (2) (2) (3) 4) (5) (6) (8)	TURF ROTOR	K-RAIN RPS75i-CV STANDARD (GREEN) NOZZLE				
Ŀ	MAINLINE CAP	FUTURE CONNECTION SCH 40 PVC CAP INSTALLED IN I KEY NOTES	CH 40 PVC CAP INSTALLED IN HIGHLINE 10" ROUND VALVE BOX. REFER TO			
	SLEEVING	CLASS 200 PVC REFER TO SLEEVING NOTES			7	LI-501
	SERVICE LINE	TYPE K COPPER SIZE: MATCH POC UNLESS OTH	ERWISE NOTED		NA	NA
	PVC MAINLINE	CLASS 200 PVC BE SIZE: 1-1/2" UNLESS OTHERWISI	ENOTED		8	LI-501
	PVC TURF LATERAL	100# NSF POLYETHYLENE PIPE SIZE: 1" MINIMUM UNLESS OTHE	RWISE NOTED		8	LI-501
	DRIP LATERAL	UV RESISTANT POLYETHYLENE SIZE: 3/4" MINIMUM UNLESS OTH	HERWISE NOTED		8	LI-501
•	FLUSH END CAP	HOSE END FLUSH CAP & OPERA INSTALLED IN HIGHLINE 10" ROU			7	LI-502
	VALVE CALLOUT		EMITTER SCI	HEDULE		
_		ER PLANT TYPE	EMITTER	QTY.	TOTA	L GPH
ZONE DESIGNATION:		PERENNIAL / GRASSES	0.5 GPH	TWO EACH	1.0	GPH
x - x	G (TURF),	DECIDUOUS SHRUBS	DECIDUOUS SHRUBS 1.0 GPH TWO EACH		2.0	GPH
X" XX		EVERGREEN SHRUBS	1.0 GPH	TWO EACH	2.0	GPH
	VALVE FLOW: (GPM)	DECIDUOUS TREE	1.0 GPH	EIGHT EACH	8.0	GPH
VALVE I LOW. (GI M) VALVE SIZE EVERGREEN			1.0 GPH	EIGHT EACH	8.0	GPH

1. ALL PLANT MATERIAL SHALL BE IRRIGATED WITH RAIN BIRD XB SERIES PRESSURE COMPENSATING EMITTERS.

2. EMITTER SCHEDULE IS FOR REFERENCE ONLY. THE CONTRACTOR SHALL ADJUST EMITTER AND NUMBER OF EMITTERS BASED ON THE NEEDS OF INDIVIDUAL PLANTS OR PLANT HYDROZONES.

3. 1/4" DISTRIBUTION TUBING NOT TO EXCEED 8' IN LENGTH

4. RAIN BIRD DBC-025 DIFFUSER BUG CAP AND TS-025 STAKE ON ALL 1/4" DISTRIBUTION TUBING EMISSION POINTS.

5. REFER TO DRIP IRRIGATION DETAILS 4-6, SHEET LI-502

IRRIGATION GENERAL NOTES

1. THE CONTRACTOR SHALL PROVIDE ALL LABOR, MATERIALS AND EQUIPMENT NECESSARY TO INSTALL THE IMPROVEMENTS SHOWN ON THE PLANS.

2. THE CONTRACTOR SHALL COORDINATE AS NECESSARY WITH THE GENERAL CONTRACTOR AND OWNER'S REPRESENTATIVE FOR SUCCESSFUL COMPLETION OF THIS WORK.

ALL IRRIGATION EQUIPMENT IS TO BE AS SPECIFIED OR APPROVED EQUAL PER THE DISCRETION OF THE OWNER'S REPRESENTATIVE. THE CONTRACTOR ASSUMES ALL LIABILITY ASSOCIATED WITH THE MODIFICATION OF THE IRRIGATION SYSTEM DESIGN WITHOUT NOTIFYING THE OWNER'S REPRESENTATIVE.

4. IT IS THE CONTRACTOR'S RESPONSIBILITY TO CONDUCT A THOROUGH SITE INSPECTION AND REVIEW OF THE PROJECT CONSTRUCTION DOCUMENTS INCLUDING BUT NOT LIMITED TO THE FOLLOWING: LANDSCAPE PLAN, UTILITY PLAN, CIVIL UTILITY PLAN, ARCHITECTURE PLAN. GRADING AND DRAINAGE PLAN AND ALL OTHER ASSOCIATED PLANS AND SPECIFICATIONS THAT AFFECT THIS WORK PRIOR TO START OF WORK. IF THE AND CONTRACTOR OBSERVES ANY DISCREPANCIES AMONG THE CONSTRUCTION DOCUMENTS AND THE EXISTING CONDITIONS ON SITE, IT IS THEIR RESPONSIBILITY TO CONTACT THE OWNER'S REPRESENTATIVE IMMEDIATELY.

5. THE CONTRACTOR MUST VERIFY THE LOCATION OF ALL PUBLIC AND PRIVATE UNDERGROUND UTILITIES PRIOR TO CONSTRUCTION. IF THE CONTRACTOR FAILS TO DO SO AND DAMAGES ANY UNDERGROUND UTILITIES. THE CONTRACTOR SHALL PAY FOR ANY REPAIR WORK ASSOCIATED WITH SAID DAMAGES.

6. IT IS THE CONTRACTOR'S RESPONSIBILITY TO ENSURE ADEQUATE VERTICAL AND HORIZONTAL SEPARATION BETWEEN ALL IRRIGATION DISTRIBUTION LINES AND ALL UTILITIES (EXISTING OR PROPOSED), CONDUIT, STORM WATER COMPONENTS, DRAINS, ETC. 7. THE CONTRACTOR SHALL CONFORM TO ALL LOCAL AND STATE REGULATIONS AND INSTALL THE IRRIGATION SYSTEM AND ITS COMPONENTS PER MANUFACTURER'S SPECIFICATIONS. THE CONTRACTOR SHALL OBTAIN AND PROVIDE PAYMENT FOR ALL PERMITS REQUIRED BY ANY LOCAL AND STATE AGENCIES AND UTILITY COMPANIES HAVING JURISDICTION OVER THIS SITE THE CONTRACTOR IS RESPONSIBLE FOR SCHEDULING AND PAYING FOR CERTIFICATION OF THE BACKFLOW PREVENTER BY A STATE CERTIFIED INSPECTOR. THE CONTRACTOR SHALL PROVIDE CERTIFICATES TO OWNER'S REPRESENTATIVE PRIOR TO PROJECT ACCEPTANCE.

9. IT IS THE INTENT OF THIS DESIGN THAT ALL IRRIGATION EQUIPMENT BE INSTALLED WITHIN LANDSCAPE AREAS AND WITHIN THE PROJECT LIMITS. EQUIPMENT SHOWN OUTSIDE OF THESE LIMITS IS SHOWN FOR GRAPHIC CLARITY ONLY. IF THERE IS A QUESTION REGARDING THE LOCATION OF ANY COMPONENT OF THE IRRIGATION SYSTEM, IT IS THE CONTRACTOR'S RESPONSIBILITY TO CONTACT THE OWNER'S REPRESENTATIVE. IF THE CONTRACTOR NEGLECTS TO NOTIFY THE NECESSARY PARTIES, THE CONTRACTOR SHALL PAY FOR ANY REPLACEMENT OR MODIFICATION TO ENSURE PROPER LOCATION AND OPERATION OF THE IRRIGATION SYSTEM AND ITS COMPONENTS

10. ALL IRRIGATION DISTRIBUTION LINES AND EQUIPMENT INCLUDING BUT NOT LIMITED TO, MAINLINE, LATERALS, SPRAY HEADS, DRIP EMITTERS SHALL BE KEPT A MINIMUM DISTANCE OF 6' AWAY FROM ALL BUILDING AND WALL FOUNDATIONS, OR AS STIPULATED IN THE GEOTECHNICAL REPORT, WHICHEVER IS GREATER. EQUIPMENT MAY BE SHOWN IN THIS AREA FOR GRAPHIC CLARITY. COORDINATE ALL REQUIRED SETBACKS WITH OWNER'S REPRESENTATIVE PRIOR TO START OF WORK.

11. EACH VALVE SHALL BE INSTALLED IN A SEPARATE VALVE BOX AS DETAILED. ALL VALVE BOXES AND LIDS SHALL BE COMMERCIAL GRADE, PLASTIC WITH SELF LOCKING COVERS. LID COLOR TO BE GREEN. INSTALL FLUSH TO FINISH GRADE AND PER CONSTRUCTION DETAILS. DO NOT INSTALL IN PAVED AREAS OR IN BOTTOMS OF DRAINAGE SWALES/BASINS.

12. CONTRACTOR SHALL INSTALL DETECTABLE MARKING TAPE OR #14g DIRECT BURY TRACER WIRE IN ALL PRESSURE MAINLINE TRENCHES. SEE IRRIGATION DETAILS FOR MORE INFORMATION.

13. PLANT MATERIAL LOCATIONS TAKE PRECEDENCE OVER ROUTING OF IRRIGATION PIPING. COORDINATE INSTALLATION OF IRRIGATION EQUIPMENT SO THAT IT DOES NOT INTERFERE WITH THE PLANTING OF TREES OR OTHER LANDSCAPE MATERIAL

14. THE CONTRACTOR SHALL MARK THE LOCATION OF THE MAINLINE, CONTROL VALVES, GATE VALVES AND HEAD LAYOUT OF A REPRESENTATIVE SPRAY ZONE. SCHEDULE A REVIEW WITH THE OWNER'S REPRESENTATIVE PRIOR TO INSTALLATION. 15. INSTALL SCH. 40 BALL WITH OPERATIONAL INDICATOR AT ENDS OF ALL DRIP LATERALS AS DETAILED. FLUSH ALL LATERALS THOROUGHLY BEFORE INSTALLING EMITTERS AND BUBBLERS

16. CONTRACTOR SHALL FINE TUNE AND ADJUST NOZZLE DIRECTION AND RADIUS TO REDUCE OVERSPRAY ONTO PAVING OR HARD SURFACES.

17. CONTRACTOR SHALL INSTALL A QUICK COUPLER IN 10" VALVE BOX AT THE END OF ALL BRANCHES OF THE MAINLINE, OR AS SHOWN ON PLANS, FOR WINTERIZATION AND FLUSHING OF MAINLINE.

18. THE CONTRACTOR SHALL PERFORM A PRESSURE TEST ON ALL MAINLINES. CONTRACTOR SHALL PRESSURIZE MAINLINES TO 120 PSI AND MAINTAIN PRESSURE AT 120 PSI FOR A MINIMUM CONTINUOUS PERIOD OF TWO (2) HOURS TO ACHIEVE FINAL ACCEPTANCE. 19. THIS IRRIGATION SYSTEM HAS BEEN DESIGNED TO OPERATE DURING A THREE(3) NIGHT PER WEEK, SIXTEEN(16) HOURS PER NIGHT WATERING WINDOW. DRIP IRRIGATION ZONES MAY BE ALLOWED TO RUN ON A SEPARATE SCHEDULE FROM THIS WATER WINDOW DEPENDING JURISDICTION. LANDSCAPE ESTABLISHMENT WILL REQUIRE INCREASED IRRIGATION WATER FOR DURATION OF THE ESTABLISHMENT PERIOD AND MAY REQUIRE TWICE THE AMOUNT OF WATER AS ESTABLISHED PLANT MATERIAL. THE CONTRACTOR SHALL COORDINATE WATERING SCHEDULES AND APPLICATION RATES WITH THE OWNER'S REPRESENTATIVE PRIOR TO FINAL ACCEPTANCE.

20. THE DESIGN IS BASED ON THE FOLLOWING PROJECTED PEAK SEASON WEEKLY APPLICATION RATES AFTER ESTABLISHMENT. THESE FIGURES WILL NEED TO BE ADJUSTED DUE TO SEASONAL CHANGES AND VARIABLE WEATHER CONDITIONS.

FESCUE/BLUEGRASS BLEND TURF 1.50" PER WEEK PEAK SEASON

TREE, SHRUB, AND PERENNIAL PLANT MATERIAL 0.75" PER WEEK PEAK SEASON

NATIVE DRAUGHT TOLERANT SEED MIX 0.50" PER WEEK PEAK SEASON

23. THE CONTRACTOR SHALL PROVIDE A SEASONAL MAINTENANCE SCHEDULE WHICH SHALL BEGIN ON MAY 15TH AND END ON SEPTEMBER 15TH TO ENSURE THE EFFICIENCY AND LONGEVITY OF THE IRRIGATION SYSTEM. THE MAINTENANCE SCHEDULE SHALL INCLUDE BUT IS NOT LIMITED TO THE FOLLOWING LIST OF BEST MANAGEMENT PRACTICES:

CHECK HEADS FOR COVERAGE AND LEAKAGE.

CHECK CONTROLLER PROGRAMMING AND ADJUST FOR SEASONAL CHANGES AS NECESSARY.

VERIFY THAT THE WATER SUPPLY AND PRESSURE ARE AS STATED IN THE DESIGN.

CERTIFY THE BACKFLOW PREVENTION DEVICE AND SUBMIT TEST RESULTS TO THE PROPERTY MANAGER.

 PERIODICALLY VERIFY THE THE SENSORS IN THE IRRIGATION SYSTEM ARE OPERATING CORRECTLY. WINTERIZATION AND SPRING START UP PROCEDURES.

IRRIGATION POINT OF CONNECTION NOTES

POINT OF CONNECTION: THERE IS ONE (1) POINT OF CONNECTION ON THIS PROJECT POC #1 : 1" DEDICATED IRRIGATION WATER METER LOCATED AT EAST OF MARINA OFFICE.

- SENSOR, GATE VALVE, AND EXTEND MAINLINE TO VALVES AS SHOWN.

 - PRIOR TO INSTALLATION.
- - CONTROLLER.

 - FLOW SENSOR REQUIRES A MINIMUM FLOW OF 0.22 GPM.
 - COMMUNICATION AND CONNECTIVITY OPTIONS.

CONVENTIONAL WIRE NOTES

- BUNDLED TOGETHER BY BLACK ELECTRICAL TAPE EVERY 10 L.F.
- AND ORDERLY FASHION AT EACH SLICE POINT.

SLEEVING COORDINATION NOTES

- CONSTRUCTION.

- SHALL BE LOCATED UNDER ANY OBSTRUCTIONS.
- PIPING

MAINLINE PIPING LATERAL PIPING **CONTROL WIRES**

CONTRACTOR IS TO LOCATE AND CONNECT DOWNSTREAM OF THE DEDICATED POTABLE IRRIGATION WATER METER (PROVIDED BY OTHERS) WITH TYPE K COPPER AT A DEPTH OF 120" OR PER LOCAL CODE, WHICHEVER IS GREATER. EXTEND COPPER TO BACKFLOW PREVENTION UNIT. EXTEND COPPER TUBING MINIMUM 30" HORIZONTAL FROM BACKFLOW PREVENTER AND INSTALL ONE MANUAL DRAIN, TRANSITION TO AND EXTEND CLASS 200 PVC MAINLINE TO THE 1" QUICK COUPLER, MASTER VALVE, FLOW

 ALL PIPING FROM THE DEDICATED IRRIGATION POTABLE METER THROUGH DRAIN VALVE DOWNSTREAM OF THE BACKFLOW PREVENTION UNIT SHALL BE THE SAME SIZE AS THE METER UNLESS OTHERWISE NOTED.

THE CONTRACTOR SHALL CONFORM TO ALL LOCAL CODES, OBTAIN AND PROVIDE PAYMENT FOR ALL PERMITS ASSOCIATED WITH THIS WORK. FINAL LOCATION OF BACKFLOW PREVENTION UNIT SHALL BE APPROVED BY THE OWNER'S REPRESENTATIVE

CONTROLLER LOCATION: THERE IS ONE (1) CONTROLLER ON THIS PROJECT

CONTROLLER A : PEDESTAL MOUNTED CONTROLLER LOCATED ADJACENT TO IRRIGATION WATER METER. CONTROLLER SHALL BE PROGRAMMED TO RUN MULTIPLE VALVES AT ONE TIME WITH A MAXIMUM TOTAL OF 18 GPM. CONTROLLER, TO BE MOUNTED PER DETAILS AND MANUFACTURER'S SPECIFICATIONS

 CONTRACTOR TO COORDINATE WITH OWNER'S REPRESENTATIVE AND ELECTRICAL PLANS FOR POWER SERVICE. ALL ELECTRICAL EQUIPMENT AND POWER CONNECTION INSTALLATION SHALL CONFORM TO ALL LOCAL CODES. INSTALL A LINE VOLTAGE SURGE DEVICE (INTERMATIC AG2401C3/ OR SQUARE D SDSA1175) FOR 120V IN A JUNCTION BOX PRIOR TO

RAIN/FREEZE SENSOR: MOUNT THE RAIN SENSOR ON BUILDING EAVE IN PROXIMITY TO THE CONTROLLER. THE SENSOR SHALL BE MOUNTED IN A LOCATION IN FULL SUN AND OPEN TO RAINFALL. SENSOR SHALL BE NO MORE THAN 200' FROM WIRELESS RECEIVER. MOUNT WIRELESS RECEIVER ON OR ADJACENT TO THE IRRIGATION CONTROLLER.

SYSTEM PRESSURE: THE SYSTEM HAS BEEN DESIGNED PER THE FOLLOWING SPECIFICATIONS: REQUIRED MINIMUM STATIC PRESSURE OF 75 PSI AND MAXIMUM SAFE VELOCITY OF 5 FPS IN ANY PVC PIPE AND 7.5 FPS IN ANY COPPER PIPE.

 THE CONTRACTOR IS RESPONSIBLE FOR VERIFYING THE PRESSURE IN THE FIELD AT THE POINT OF CONNECTION BEFORE CONSTRUCTION BEGINS AND FOR NOTIFYING THE OWNER'S REPRESENTATIVE OF ANY DISCREPANCY BETWEEN THE DESIGN PRESSURE OF THE SYSTEM AND THE MEASURED PRESSURE IN THE FIELD. IF THE CONTRACTOR FAILS TO NOTIFY OWNER'S REPRESENTATIVE OF SUCH DISCREPANCIES, THEN THE CONTRACTOR ASSUMES ALL LIABILITY AND COSTS ASSOCIATED WITH SYSTEM MODIFICATIONS TO ACCOMMODATE THE ACTUAL PRESSURE.

• FLOW SENSOR: SENSOR REQUIRES A MINIMUM FLOW FOR PROPER READINGS. MULTIPLE ZONES MAY BE REQUIRED TO RUN SIMULTANEOUSLY TO ACHIEVE THE MINIMUM FLOWS REQUIRED. CONTRACTOR TO SET 'K' VALUES PER MANUFACTURER.

COMMUNICATION: IT IS RECOMMENDED THAT THE IRRIGATION CONTROLLER BE CONNECTED TO A WATER MANAGEMENT CONTROL SOFTWARE FOR OPTIMUM FUNCTION OF THE IRRIGATION SYSTEM. COORDINATE WITH OWNER'S REPRESENTATIVE AND CONTACT THE LOCAL CONTROLLER MANUFACTURER REPRESENTATIVE OR AUTHORIZED VENDOR PRIOR TO ORDERING CONTROLLER FOR

GROUNDING FOR THE IRRIGATION CONTROLLER SHALL BE INSTALLED PER THE MANUFACTURER'S SPECIFICATIONS AND PER THE AMERICAN SOCIETY OF IRRIGATION CONSULTANTS GUIDELINE 100-2002 FOR EARTH GROUNDING ELECTRONIC EQUIPMENT IN IRRIGATION SYSTEMS FOUND AT www.asic.org/Design_Guides.aspx. FOR TECHNICAL SUPPORT REGARDING THE IRRIGATION CONTROLLER OR GROUNDING PLEASE CONTACT THE MANUFACTURER.

NEW CONTROLLER WIRE SHALL BE 14GA MIN. UL APPROVED WIRE. CONTRACTOR SHALL VERIFY EXISTING CONNECTIONS AND USE UL APPROVED WIRE STRIPPER AND 3M DBY WATERPROOF CONNECTIONS AT ALL NEW SPLICES AND CONNECTION POINTS. CONTRACTOR TO INSTALL RED ELECTRIC MARKING TAPE WITH CONTROLLER WIRE THAT IS NOT WITH MAINLINE. WIRES SHALL BE

CONTRACTOR SHALL HAVE 30" OF SPARE CONTROL WIRE PRESENT AT ALL SPLICE POINTS. SPARE WIRE SHALL BE COILED IN A NEAT

4. CONTRACTOR SHALL EXTEND TWO (2) SPARE CONTROL WIRES, AND ONE (1) SPARE COMMON WIRE AT THE END OF THE MAINLINE. CONTRACTOR SHALL INSTALL ONE (1) WIRE PULL BOX AT EACH END OF THE MAINLINE.

INSTALLATION OF IRRIGATION SLEEVING IS THE RESPONSIBILITY OF THE GENERAL CONTRACTOR. THE GENERAL CONTRACTOR SHALL COORDINATE WITH THE IRRIGATION CONTRACTOR FOR LOCATION AND SIZING OF SLEEVES PRIOR TO THE START OF

SLEEVES SHALL BE INSTALLED PRIOR TO THE START OF PAVING OPERATIONS.

THE CONTRACTOR SHALL SLEEVE ALL IRRIGATION DISTRIBUTION LINES, VALVE CONTROL WIRES AND COMMUNICATION WIRES UNDER ALL PAVED SURFACES, WALL FOOTERS, DRAINAGE CHANNELS, INLETS, CATCH BASINS, ETC.

ALL SLEEVES SHALL EXTEND A MINIMUM OF 12" BEYOND EDGE OF ALL OBSTRUCTIONS. NO TEES, ELLS OR OTHER TURNS IN PIPING

EACH PIPE SHALL BE IN A SEPARATE SLEEVE. WIRES SHALL BE IN A SEPARATE PIPE UNDER ALL PAVED SURFACES.

SLEEVING SHALL BE INSTALLED PER THE SIZES AND QUANTITIES SHOWN ON THE PLANS BASED ON THE CHART BELOW.

REQUIRED SLEEVE SIZE

3" CLASS 200 PVC

2X NOMINAL DIAMETER OF LATERAL

2" CLASS 200 PVC

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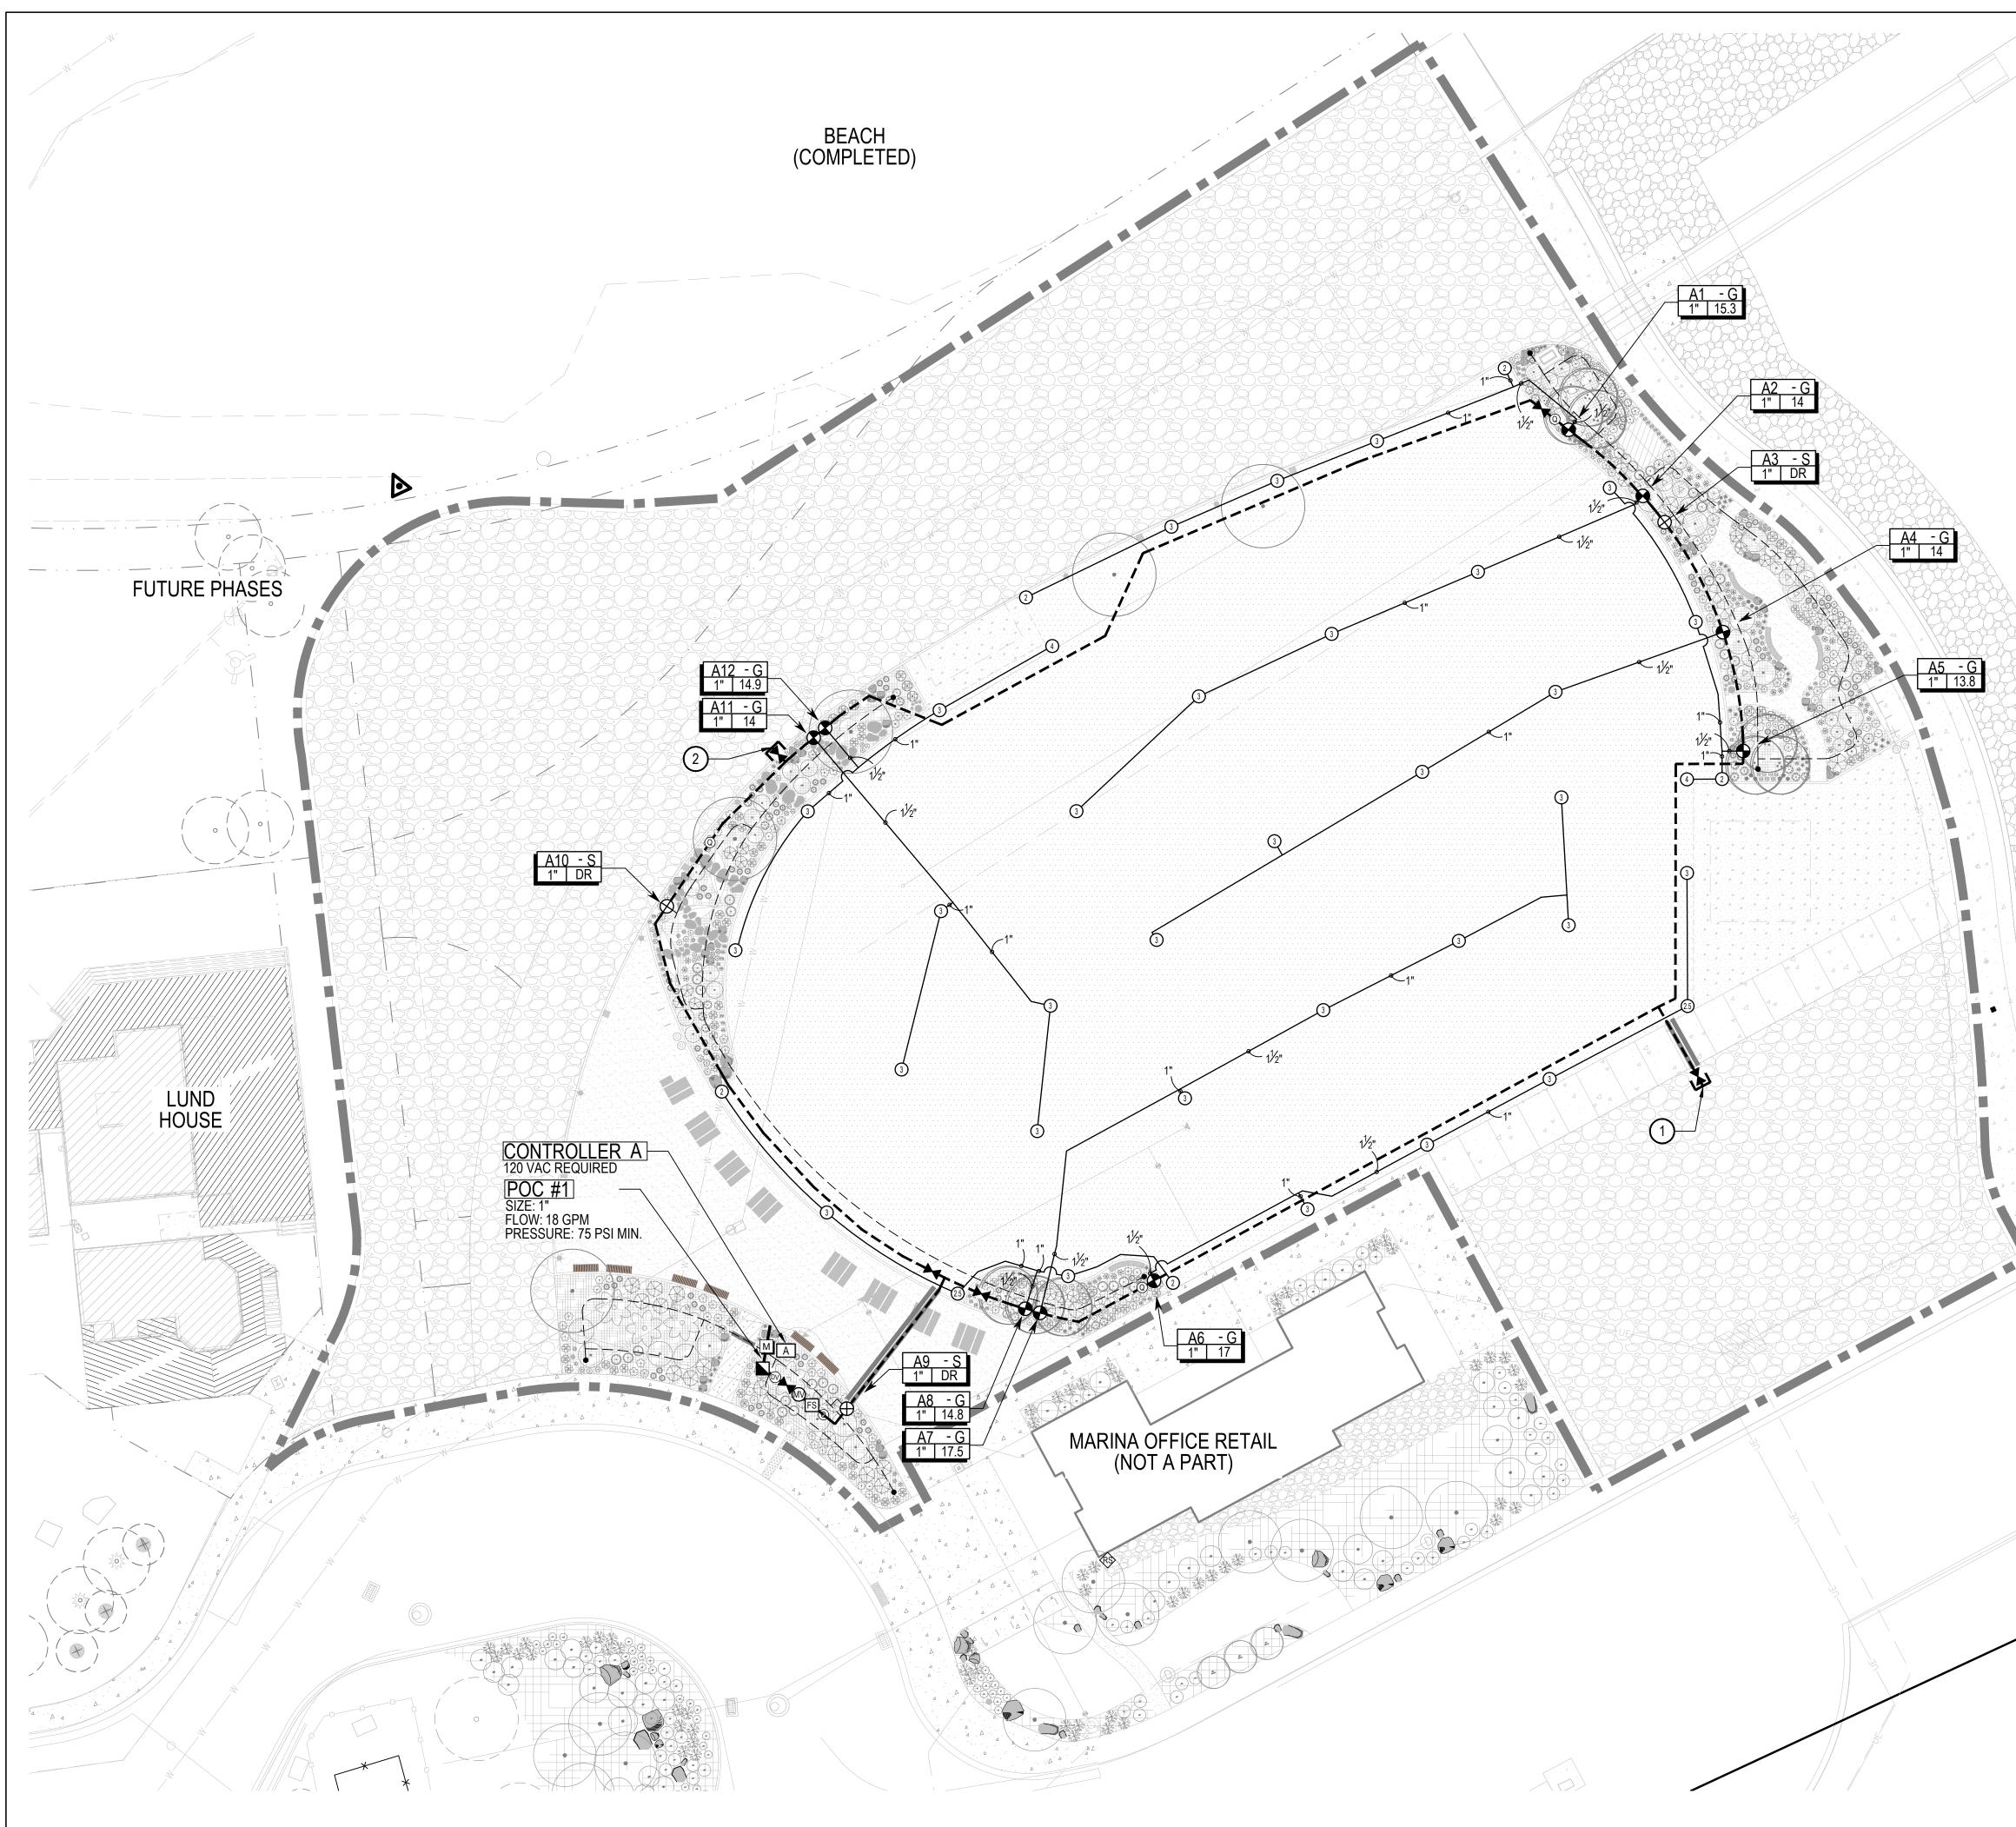
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> SHEET TITLE: IRRIGATION NOTES





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IRRIGATION KEY NOTES

1 IRRIGATION CONTRACTOR SHALL STUB NEW MAINLINE PIPING GATE VALVE, THREE (3) SPARE CONTROL WIRES, ONE (1) COMMON WIRE, ONE (1) SPARE COMMON WIRE, AND TWO (2) SPARE CONTROL WIRES TO THIS APPROXIMATE LOCATION FOR FUTURE USE. CONTRACTOR SHALL ENCLOSE WIRE BUNDLE IN 10" ROUND VALVE BOX FOR FUTURE REFERENCE.

(2) IRRIGATION CONTRACTOR SHALL STUB NEW MAINLINE PIPING GATE VALVE, SIX (6) SPARE CONTROL WIRES, ONE (1) COMMON WIRE, ONE (1) SPARE COMMON WIRE, AND TWO (2) SPARE CONTROL WIRES TO THIS APPROXIMATE LOCATION FOR FUTURE USE. CONTRACTOR SHALL ENCLOSE WIRE BUNDLE IN 10" ROUND VALVE BOX FOR FUTURE REFERENCE. CONTRACTOR SHALL NOT INSTALL GATE VALVE, MAINLINE STUB, OR SPARE WIRES IN ADJACENT FIRE LANE. THESE ITEMS SHALL BE INSTALLED IN THE PLANTING BED TO AVOID DAMAGE BY EMERGENCY VEHICLES.




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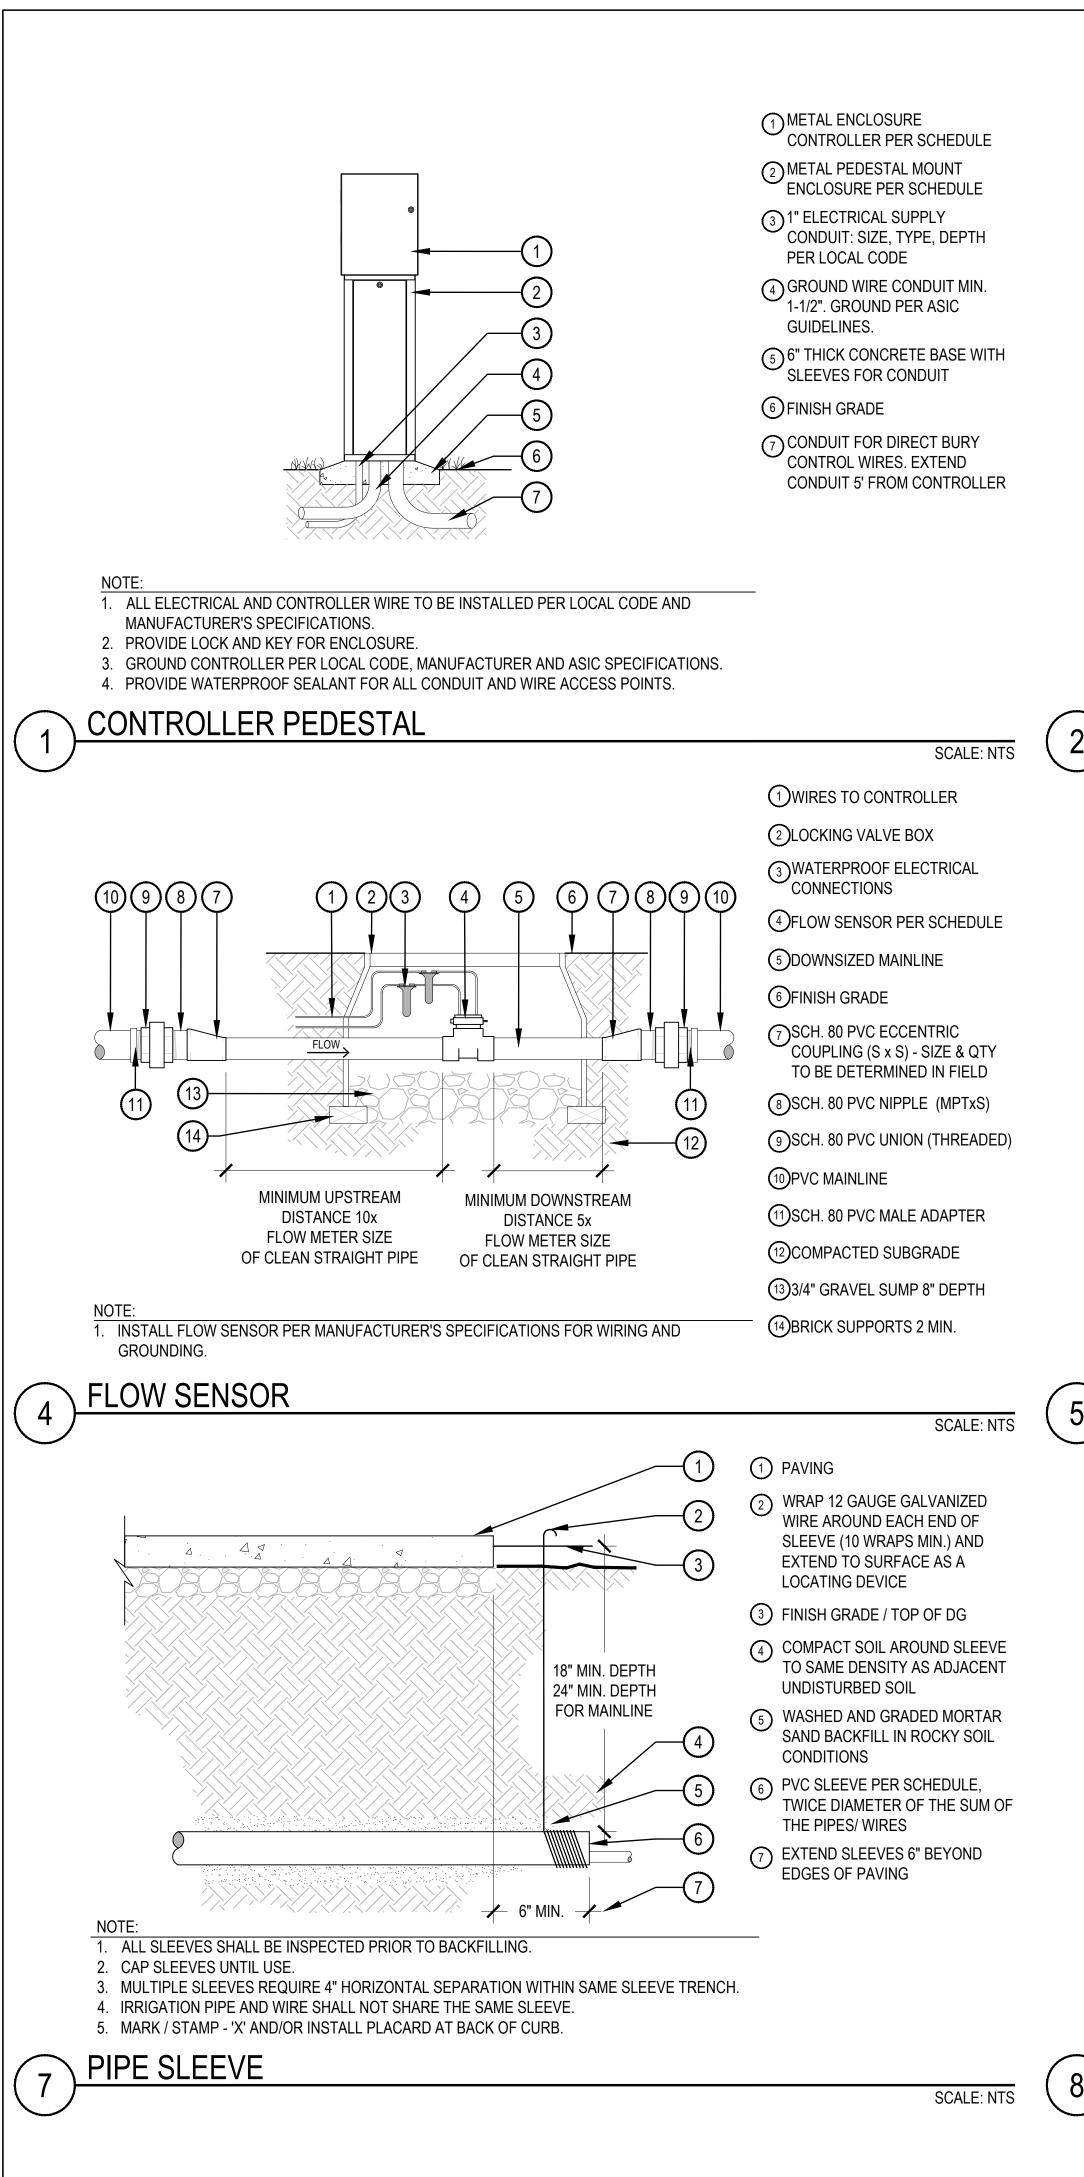
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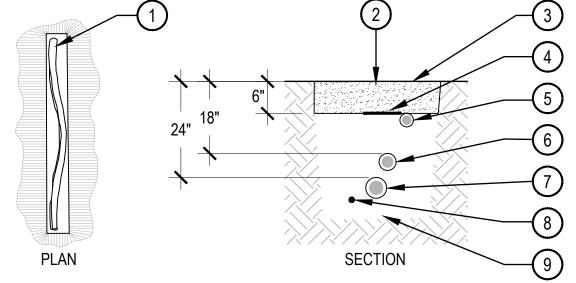
SHEET TITLE: IRRIGATION PLAN



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PIPE TRENCH

- WATER, BETWEEN LIFTS.
- 11. PIPE BEDDING MATERIAL TO BE ROCK AND DEBRIS FREE, BACKFILL IN 6" LIFTS, PUDDLE WITH
- 10. EXCAVATED COVER MATERIAL SHALL BE FREE FROM DEBRIS AND ROCKS 1/2" OR GREATER.
- 8. BEDDING MATERIAL SHALL BE IN MAINLINE TRENCH ONLY. 9. BEDDING IS NOT REQUIRED IN POLYETHYLENE TUBING TRENCHES.
- WIRE AND 3" ABOVE HIGHEST PIPE OR WEIR WITHIN TRENCH.
- 6. VALVE WIRES TO BE INSTALLED WITHIN MAINLINE TRENCH WHEREVER POSSIBLE 7. BEDDING MATERIAL SHALL BE 1/4" MINUS SAND, AND SHALL BE 3" BELOW LOWEST PIPE OR
- VALVE BOX AND MADE WITH DBY WATERPROOF CONNECTORS, OR APPROVED EQUAL. 5. BUNDLE AND TAPE WIRING AT 10' INTERVALS
- 3. ALL 120 VOLT WIRING IN CONDUIT TO BE INSTALLED AS PER LOCAL CODES. 4. ALL ELECTRICAL WIRE CONNECTIONS TO VALVES AND SPLICES TO BE INSTALLED WITHIN A
- 2. ALL PVC PIPING TO BE SNAKED IN TRENCHES AS SHOWN IN PLAN VIEW ABOVE.
- 1. ALL MAINLINES TO BE INSTALLED IN ACCORDANCE WITH MANUFACTURER' SPECIFICATIONS. 6 IRRIGATION LATERAL PIPE
- NOTE:

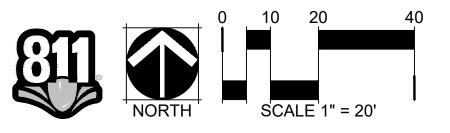

QUICK COUPLER

- AS ADJACENT UNDISTURBED SUB-GRADE. 5. ALL THREADED CONNECTIONS SHALL BE COATED WITH TEFLON TAPE.
- QUICK COUPLER SHALL HAVE LOCKING RUBBER COVER. COLOR PER LEGEND. COMPACT SOIL AROUND GATE VALVE ASSEMBLY TO THE SAME DENSITY
- PROVIDE (1) QUICK COUPLER KEY FOR EACH QUICK COUPLER VALVE
- EACH QUICK COUPLER SHALL BE IN A SEPARATE VALVE BOX


RAIN SENSOR POLE MOUNT

SYSTEM OR UNDER EAVE OF HOUSE.

3. FINAL LOCATION AND MOUNTING SYSTEM TO BE APPROVED BY OWNER.

4. SENSOR SHOULD NOT BE MOUNTED UNDER TREES, IN AREAS AFFECTED BY SPRINKLER

NOTE:

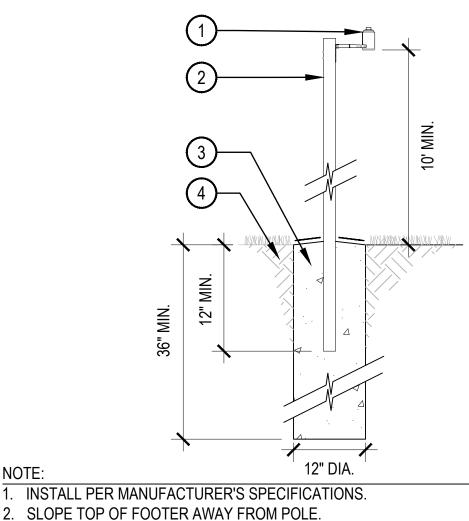

(9) BEDDING MATERIAL (SEE NOTES)

SCALE: NTS

- 8 VALVE WIRING
- (7) IRRIGATION MAINLINE PIPE
- 5 POLYETHYLENE DRIP LATERAL/ DRIP PVC LATERAL PIPE (6" MIN. COVERAGE, 18" MIN. COVERAGE BELOW PEDESTRIAN WALKS.)
- (4) MAINLINE MARKING TAPE (PURPLE MARKING TAPE IF RECLAIMED)
- 3 FINISH GRADE
- 2 EXCAVATED COVER MATERIAL (SEE NOTES)
- 1 SNAKE PVC OR POLYETHYLENE **PIPE IN TRENCH**
- SCALE: NTS
- UNDISTURBED SUBGRADE

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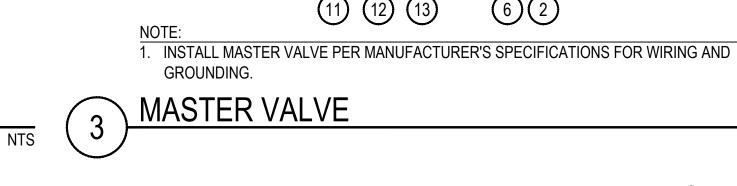
WHERE PRACTICAL


NOTE

7 PVC MAINLINE (8) 24" LONG #4 REBAR TO HOLD QUICK COUPLER IN PLACE W/


(2) STAINLESS STEEL CLAMPS


- 6 PVC SWING JOINT
- (5) 3" DEPTH 3/4" GRAVEL BASE EXTEND 6" BEYOND EDGE OF BOX
- 4 SCH. 80 PVC RISER (T x T)
- 3 QUICK COUPLING VALVE W/ LOCKING COVER PER SCHEDULE
- (2) 10" ROUND BOX & COVER PER SCHEDULE. TOP OF BOX TO FLUSH WITH FINISH GRADE
- 1 FINISH GRADE



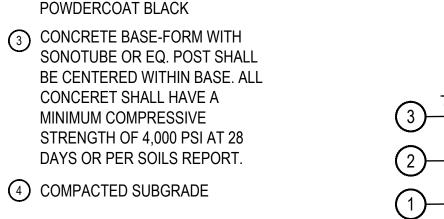

- (1) WIRELESS RAIN SENSOR, LOCATE WITHIN 500' OF THE CONTROLLER.
- 2" SQ., 12 GUAGE GALVANIZED STEEL POST. COLOR TO BE

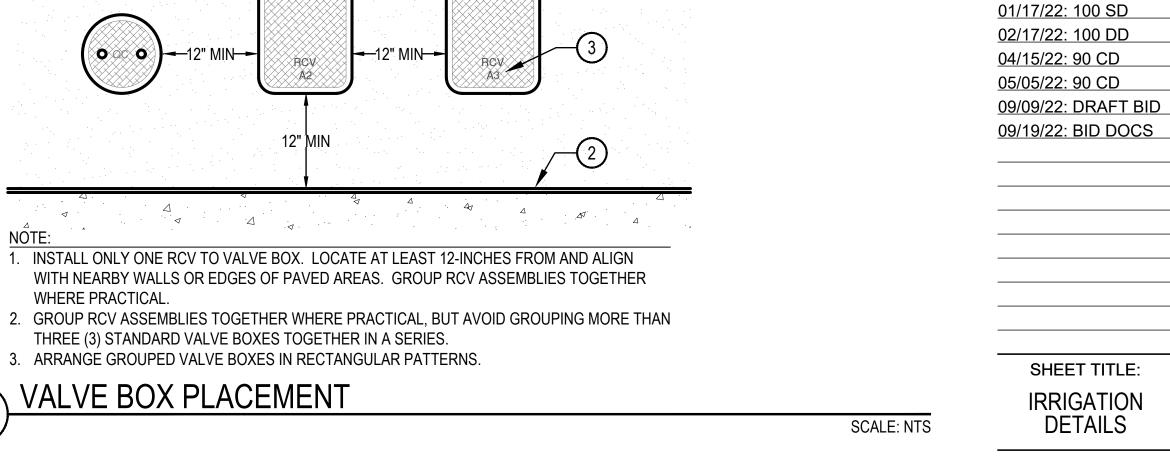

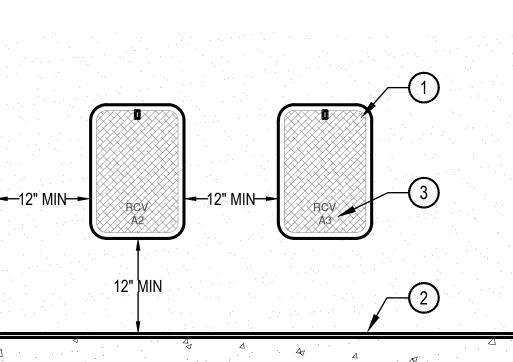




GATE VALVE 2" AND SMALLER

2. DO NOT REST VALVE BOX OR ACCESS SLEEVES ON MAINLINE OR LATERAL LINE. 3. PROVIDE GATE VALVE KEY - LENGTH AS REQUIRED.

COMPACT SOIL AROUND GATE VALVE ASSEMBLY TO THE SAME DENSITY AS ADJACENT

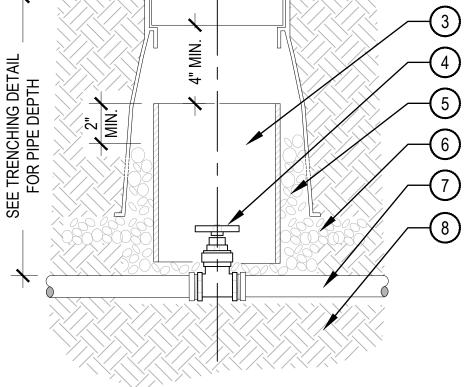

6(2)

4 5 6 7 8 9 10 1

3" MIN.

- - 5 3/4" GRAVEL SUMP FILL IN AND AROUND BOX AS REQUIRED.

 - 6 3" DEPTH 3/4: GRAVEL EXTEND 6"
 - BEYOND EDGE OF BOX

 - 7 PVC MAINLINE

 - (8) COMPACTED SUBGRADE

(1) VALVE BOX; ALIGN EVENLY AND

STRUCTURE, WALL, OR CURB

(3) VALVE BOX LID BRANDED WITH

CONTROLLER & STATION

2 SIDEWALK OR PAVING

NUMBER

SPACE EVENLY FROM SIDEWALK,

SCALE: NTS

- SCHEDULE
- AND SOLID WEDGE DISC PER
- LENGTH AS REQUIRED. (4) GATE VALVE W/ CROSS HANDLE
- 2 FINISH GRADE 3 8" SCH 40 PVC ACCESS SLEEVE
- BE FLUSH WITH FINISH GRADE
- PER SCHEDULE. TOP OF BOX TO

- SCALE: NTS 1 LOCKING ROUND BOX & COVER
- (13) COMPACTED SUBGRADE

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- (12) 3/4" GRAVEL SUMP 8" DEPTH

- (1) BRICK SUPPORTS 2 MIN.

(1) WIRES TO CONTROLLER

(8) SCH. 80 PVC UNION (THREADED)

1 PVC MAINLINE

4 FINISH GRADE

2 SCH. 80 PVC MALE ADAPTER

3 SCH. 80 PVC BALL VALVE


5 LOCKING VALVE BOX

6 SCH. 80 PVC NIPPLE

(THREADED)

7 MASTER VALVE

(9) WATERPROOF ELECTRICAL CONNECTIONS

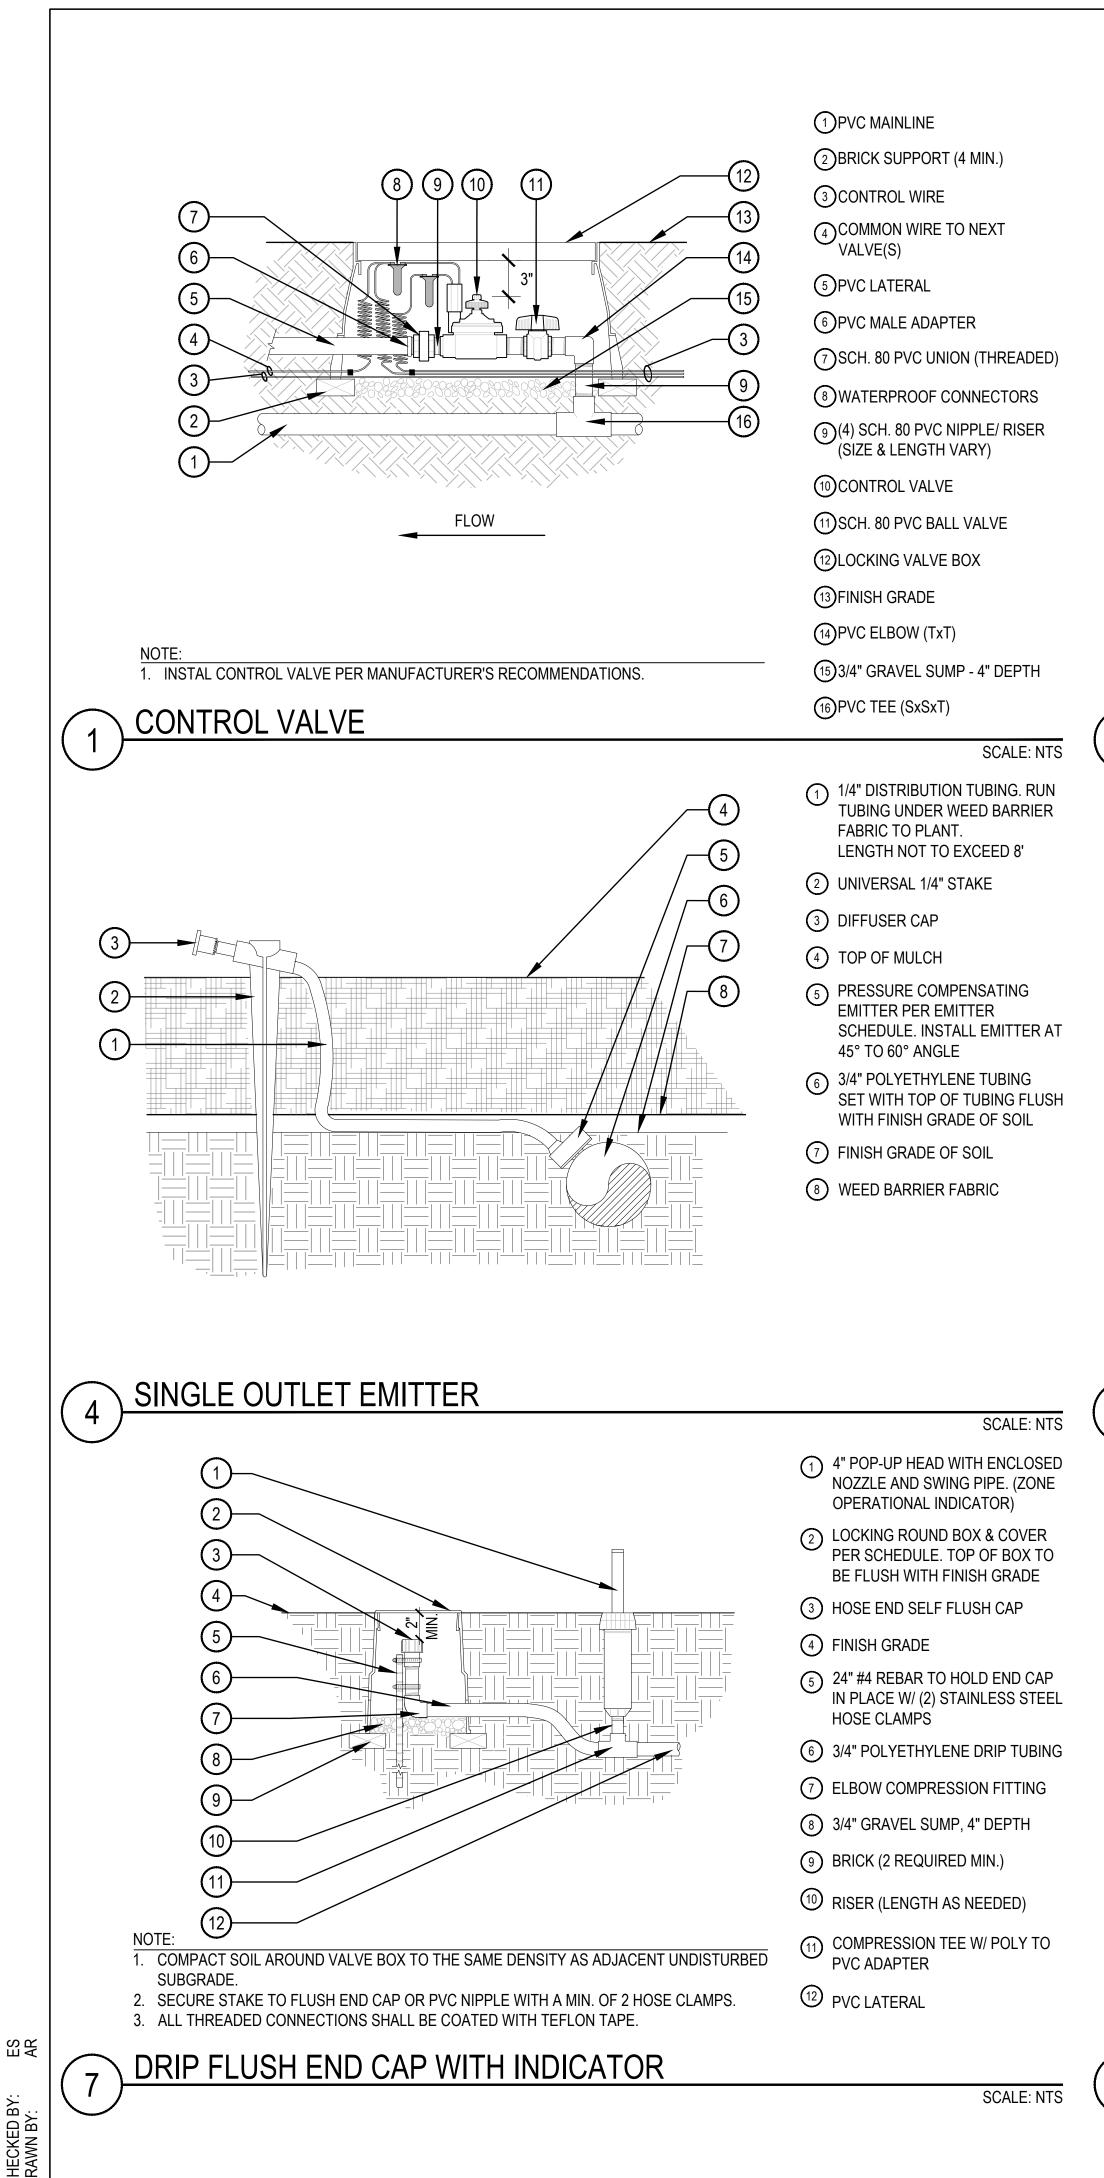


5

8

BACKFLOW FEBCO 825YA


- WATER METER AND BE THE SAME SIZE AS THE METER SERVICE LINE. 4. PROVIDE THRUST BLOCKS FOR LINES 2-1/2" OR LARGER.
- 3. BACKFLOW PREVENTION DEVICES SHALL BE PLACED A MINIMUM OF TWO (2') FEET FROM THE
- 2. PROVIDE PVC PIPE PROTECTION AROUND COPPER SUPPLY LINES AS THEY GO THROUGH THE CONCRETE SLAB BASE.
- INSTALL PER LOCAL CODES AND MANUFACTURER'S SPECIFICATIONS.

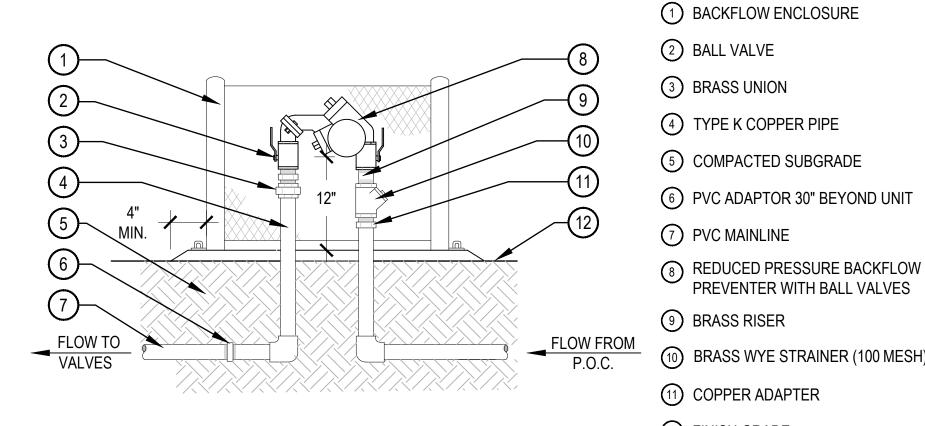

SCALE: 1/2" = 1'-0"

2. ALL BOLTS FOR MOUNTING BRACKETS SHALL BE ZINC PLATED TAMPER PROOF. 4. PROVIDE KEYED PADLOCK, MASTER LOCK MODEL #957 W/ (2) TWO KEYS FOR LOCKING SECURITY ENCLOSURE. BACKFLOW ENCLOSURE LIFT-OFF

NOTE:

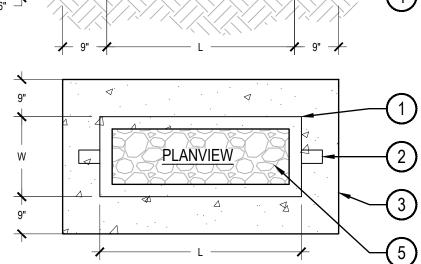

SINGLE OUTLET EMITTER PLACEMENT

- 5. CONTRACTOR SHALL ENSURE HYDROZONES ARE VALVED SEPARATELY AS SHOWN ON PLAN
- REQUIREMENTS AND SUN EXPOSURE.
- 4. DRIP VALVE ZONES (HYDROZONES) ARE DESIGNED TO ACCOUNT FOR DIFFERENCES IN PLANT
- 3. EMITTERS SHALL BE SELF-FLUSHING PRESSURE COMPENSATING-TYPE UNLESS NOTED OTHERWISE.
- 2. IF PLANTING ON A 4:1 SLOPE OR STEEPER, INSTALL EMITTERS ON THE UPHILL SIDE OF PLANT.
- 1. EMITTERS SHALL BE EQUALLY SPACED AROUND ROOTBALL 2. FLUSH ALL LINES THOROUGHLY PRIOR TO EMITTER INSTALLATION.


NOTE:

(1)

2-

3-

(4)

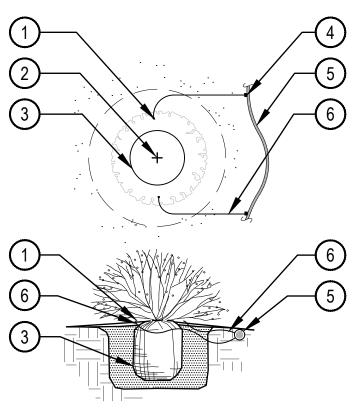

6 1/4" DISTRIBUTION TUBING (LENGTH NOT TO EXCEED 8')

- 5 3/4" POLYETHYLENE DRIP TUBING
- 4 SINGLE OUTLET EMITTER
- 3 PLANT ROOTBALL
- 2 PLANT CENTER

2 BALL VALVE

3 BRASS UNION

7 PVC MAINLINE

(9) BRASS RISER

(1) COPPER ADAPTER

12 FINISH GRADE

5 COMPACTED SUBGRADE

PREVENTER WITH BALL VALVES

(10) BRASS WYE STRAINER (100 MESH)

1 DIFFUSER CAP W/ DRIP STAKE

SCALE: NTS

- (13) PVC MAINLINE
- 12 SCH. 80 PVC TEE (SxSxT)
- WIRES FROM CONTROLLER
- (1) CONTROL AND COMMON
- 10 SCH. 80 PVC BALL VALVE
- (9) CONTROL VALVE PER LEGEND
- 8 VALVE BOX PER LEGEND, FLUSH TOP OF BOX W/ GRADE
- (7) 4" DEPTH GRAVEL SUMP
- (13) ⁽⁶⁾ BRICK SUPPORT (4 MIN)
- 4 PVC COUPLING (FPTxFPT) 5 PVC LATERAL
- -(10) (3) (2) SCH. 80 PVC UNION (THREADED)
- 9 2 30" COIL OF WIRE MINIMUM. PLACED IN BOX.
- -(8) (1) WATERPROOF CONNECTORS

(10)


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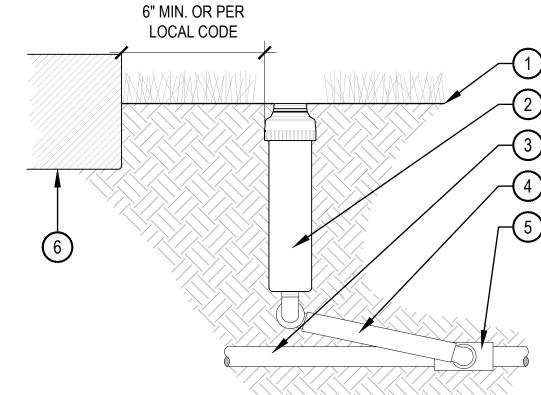
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SCALE: NTS

ROTOR POP-UP

- COURTS, ETC.
- CODES
- 1. SET TOP OF HEAD FLUSH WITH FINISH GRADE. ADJUSTABLE ARC NOZZLES SHALL BE USED ON CURVED OR NON-STANDARD ANGLED EDGES. 3. ROTORS SHALL BE INSTALLED 6" MININUM FROM ANY WALLS, WALKS, COURTS, ETC. PER LOCAL



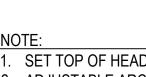

INSTALL DRIP CONTROL ZONE KIT PER LPVC TO POLY POLY-/ MANUFACTURER'S SPECIFICATIONS FOR FITTING

Drip valve to pvc connection

Refer to legend for type of

connection required

FLOW

Drip valve to poly connection

Refer to legend for type of connection required

DRIP CONTROL ZONE KIT

1. BUNDLE & TAPE WIRE EVERY 10 FT. SEAL

2. 30" MINIMUM LENGTH OF CONTROL WIRE

PROOF CONNECTION TO SOLENOID.

COILED AND PLACED IN BOX AT WATER

MATERIAL

WIRING

WIRE ENDS WITH WATERPROOF SPLICING

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- 1 FINISH GRADE
- (2) ROTOR SIZE PER PLAN
- 3 PVC LATERAL PIPE
- SWING JOINT ASSEMBLY
- (5) PVC SCH. 40 TEE OR ELL (S x T)
- 6 WALLS, WALKS, COURTS, CURB, ETC.

SCALE: NTS

SCALE: NTS

1 EMISSION POINT. DIFFUSER CAP

4 SECOND EMISSION POINTS SEE

W/ DRIP STAKE (TYP.)

(2) PLANT ROOT BALL (TYP.)

3 PLANT CENTER (TYP.)

NOTE 3 BELOW

7 1/4" DISTRIBUTION TUBING

Indle outlet emitter

1 LIFT-OFF GUARDSHACK

G CONCRETE PAD - PAD TO BE 9"

LARGER ON ALL SIDES FROM

INTERIOR DIMENSIONS OF

5 3/4" CRUSHED GRAVEL,

GUARDSHACK ENCLOSURE

CONCRETE HOLE OPENING

DIMENSION PER CHART

ENCLOSURE

(2) LOCK SHIELD

4 FINISH GRADE

(LENGTH NOT TO EXCEED 8')

(8) 3/4" POLYETHYLENE DRIP TUBING


5 TREE TRUNK

6 MULCH LAYER

10 ROOTBALL

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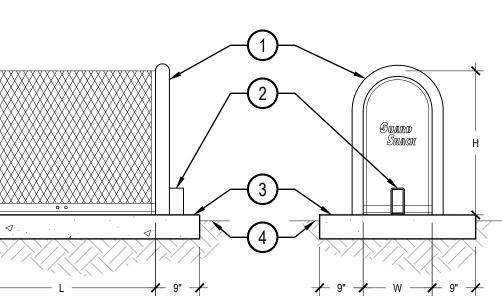
- 4. ADJUST ALL ROTOR HEADS SO THAT NO OVERSPRAY OCCURS ON ANY WALLS, WALKS,
- 5. ALL THREADED CONNECTIONS SHALL BE COATED WITH TEFLON TAPE.

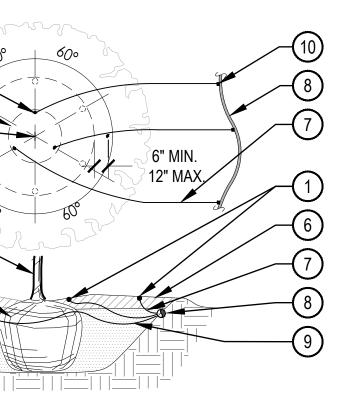

- . MAXIMUM LENGTH OF ONE DISTRIBUTION TUBE SHALL BE 8
- 2. ALL EMISSION POINTS SHALL BE LOCATED ON UPHILL SIDE OF PLANT MATERIAL. ONE EMISSION POINT SHALL BE DIRECTLY TO PLANT BALL AS INDICATED. ADDITIONAL EMISSION POINTS SHALL BE WITHIN PLANT PIT PERIMETER AS DIRECTED IN THE EMITTER SCHEDULE. SECOND EMISSION POINTS (IF NEEDED) AS PER THE EMITTER SCHEDULE FOR TREES WITH 3" CALIPER OR GREATER OR CONIFEROUS TREES 10' OR GREATER IN HEIGHT 4. THIS IS A WATERING GUIDE ONLY. SITE, SOIL AND PLANT CONDITIONS VARY GREATLY. CONTRACTOR MUST OBSERVE THE PLANT MATERIAL AND MAKE ADJUSTMENTS AS

TREE EMITTER PLACEMENT

NECESSARY FOR PROPER PLANT WATER REQUIREMENT.



	ANDARD LIFT-OFF RDSHACK INTERNAL DIMENSIONS	CONCRETE HOI OPENING
GS5	10"W x 18"H x 12"L	8"W x 21"L
GS-1	10"W x 24"H x 22"L	8"W x 21"L
GS-2	10"W x 24"H x 30"L	8"W x 29"L

1. INSTALL GUARDSHACK LIFT-OFF UNIT 51 POWDER COATED STEEL GUARD SHACK PER MANUFACTURER'S SPECIFICATIONS. 3. PRODUCT AVAILABLE FROM GUARDSHACK 3831 E. GROVE ST. PHOENIX, AZ 85040, PH: (602) 426-1002 EXT. 422 FX: (602) 426-1005

SCALE: NTS

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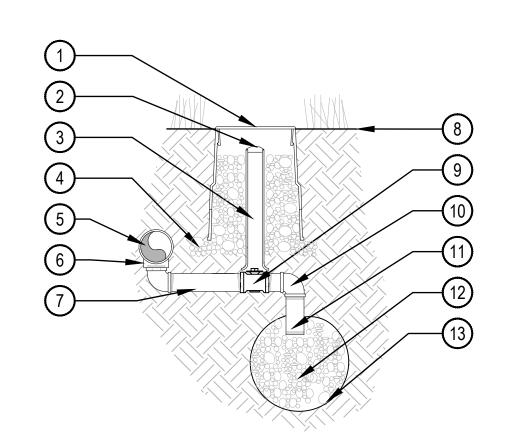
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DATE:
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02/17/22: 100 DD
04/15/22: 90 CD
05/05/22: 90 CD
09/09/22: DRAFT BID
09/19/22: BID DOCS

SHEET TITLE: IRRIGATION DETAILS



NOTE:

1

1. ALL THREADED CONNECTIONS SHALL BE COATED WITH TEFLON TAPE.

2. LOCATE DRAIN VALVE AT POINT OF CONNECTION AND AT ALL LOW POINT(S) ALONG THE (2) 3/4" GRAVEL SUMP - 1 CU. FT. MIN IRRIGATION MAINLINE AS NEEDED.



- 10" LOCKING ROUND BOX & COVER PER SCHEDULE. TOP OF BOX TO BE FLUSH WITH FINISH GRADE.
- 2 2" VALVE MARKER
- 3 2" CL160 PVC ACCESS SLEEVE LENGTH AS REQUIRED.
- 3" DEPTH 3/4" CRUSHED GRAVEL 6" BEYOND EDGE OF BOX
- 5 PVC PRESSURE MAIN LINE
- 6 SCH. 80 TEE PER MAINLINE SIZE. ALIGN IN A DOWNWARD POSITION
- (7) SCH. 80 PVC NIPPLE
- 8 FINISH GRADE
- 1" BRONZE STOP VALVE WITH SLOTTED KEY OPERATOR
- (10) SCH. 80 PVC ELL
- 1) SCH. 80 PVC NIPPLE
- (13) SOIL BLANKET ENCLOSING SUMP AMOCO ENG. FABRIC 4545 4.5 OZ. OR EQUAL

SCALE: NTS

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> SHEET TITLE: IRRIGATION DETAILS

> > LI-503